



**FOREST PARK SOUTHEAST  
DEVELOPMENT COMMITTEE**

April 23, 2019

5:30 P.M.

**MEETING AGENDA**

1. **Introductions** .....5 Minutes
2. **Minutes from March 26, 2019** .....2 Minutes
3. **4170 Manchester:** Request for Community support for a Conditional Use
  - Park Central Presentation.....5 Minutes
  - Business Presentation .....5 Minutes
  - Public Comments.....5 Minutes
  - Committee Comments.....5 Minutes
4. **900 Sarah:** Request for Razing a building and new construction of Townhomes
  - Park Central Presentation.....5 Minutes
  - Business Presentation .....5 Minutes
  - Public Comments.....5 Minutes
  - Committee Comments.....5 Minutes
5. **Closed Session** .....10 Minutes



**FPSE Development Committee Meeting Minutes  
March 26, 2019 at 5:30 pm  
at 4512 Manchester, St. Louis, MO 63110**

**Committee members in attendance:** John Boldt, Guy Slay, Brian Phillips, Tom Ernst, Kasan Moorehead, Sharon Blaine, Mark Mangapora

**Committee members not present:** Meredith Jones, David Wolfe, Patrick Brown, Patrice Willis

**Staff in attendance:** Abdul Abdullah and Annette Pendilton

**Others in attendance:** Tonnie Smith and Keaua Anderson (Cornerstone/West End), Katie May (May's Place), Dan Harbaugh (Ronald McDonald House), AB and May Eizenberg (Babylon), Dan (FPSENA)

**1. Call to Order:**

J. Boldt called the meeting to order at 5:31 pm.

**2. Minutes from February 26, 2019**

B. Phillips motioned to approve minutes for February 26, 2019. M. Mangapora seconded. Motion passes 4-0-2 Abstained – J. Boldt, S. Blaine

**3. 4180 Manchester:** Request for community support for Conditional Use

A. Abdullah read the proposal to the board. Copy of the report can be requested with Park Central Development staff.

Park Central Development recommends support of the project with the following conditions:

1. The business owner will sign the Grove CID Good Neighbor Agreement.
2. Any additional changes in the specified use, or any additional changes to the project requiring a variance should be brought before the FPSE Development Committee for review.

Katie May presented to the board.

**4. 4322-24 Swann:** Request for Razing a building and new contraction of Townhomes

Abdullah read the proposal to the board. Copy of the report can be requested with Park Central Development staff.

Park Central Development recommends support of the project with the following conditions:

1. Repair if needed the sidewalk in front of the property.

2. Immediately clear the fence line and alley surrounding the property of overgrowth and trash on the property line.
3. Conform to the design recommendations that the Director of Cultural Resources for the City of St. Louis recommends per the form base code.
4. Any additional changes in the specified use, or any additional changes to the project requiring a variance should be brought before the FPSE Development Committee for review.

May Eizenberg and AB with Babylon presented to the board.

5. **Ronald McDonald Update-** Dan Harbaugh updated that the preservation board approved demolish of the church so they can go forward with the Ronald McDonald House. He thanked Abdul Abdullah, Guy Slay and Brian Phillips for their support through this process. He also passed out renderings on what the building would look like and stated that any suggestions or changes are welcomed.

**6. Closed Session**

**A. 4180 Manchester -**

G. Slay motioned to support and Conditional Use with the following conditions:

1. The business owner will sign the Grove CID Good Neighbor Agreement.
2. Any additional changes in the specified use, or any additional changes to the project requiring a variance should be brought before the FPSE Development Committee for review.

B. Phillips seconded. The motion passes 7-0-0

**B. 4322-4324 Swann -**

G. Slay motioned to reject for demolition of the site and believes the site can be restored. M. Mangapora seconded. The motion passes 7-0-0

**7. Meeting adjourned at 6:30 pm.**

4170 Manchester

**Site Address:** 4170 Manchester

**Request:** Letter of Support for Patio Improvements

**Company Name:** Parlor

Contact Person(s): Gabe McKee

**Mailing Address:** 2717 Sutton Blvd St. Louis MO 63143

**Company Owners / Principals:** Sean Baltzell

**Project Information**

**History of site**

Currently home of Parlor.

**Proposed Project**

Parlor is proposing removal of its current wooden fence and replacing it with an 18' long shipping container and steel fence. The container will have one side removed facing the patio which will allow for covered seating within the container. Murals similar to that on the existing patio would be implemented on the street and patio side of the shipping container.

**Parking**

N/A

**Current Zoning** Neighborhood Center, Type 1

**Project Costs:**

Acquisition:	N/A
Pre-development Soft Cost:	\$ 1,500
Construction Cost:	\$ 8,500
Total:	\$ 10,000

4170 Manchester

**Project Timeline:**

Site Control:	Yes
Construction Start:	5/2019
Construction Complete:	5/2019
Occupancy:	Existing

**Relevant Experience**

Parlor has operated since 2016 and has a second business opening in Chroma in the Summer of 2019.

**Will the project seek financial incentives from the City of St. Louis?** No Incentives will be given.


**Park Central Recommendation**

Park Central Development recommends support for the owner's conditional use with the following conditions:

1. The Business will sign the Grove Good Neighbor Agreement.
2. Any additional changes in the specified use, or any additional changes to the project requiring a variance should be brought before the FPSE Development Committee for review.

4170 Manchester

### Map View

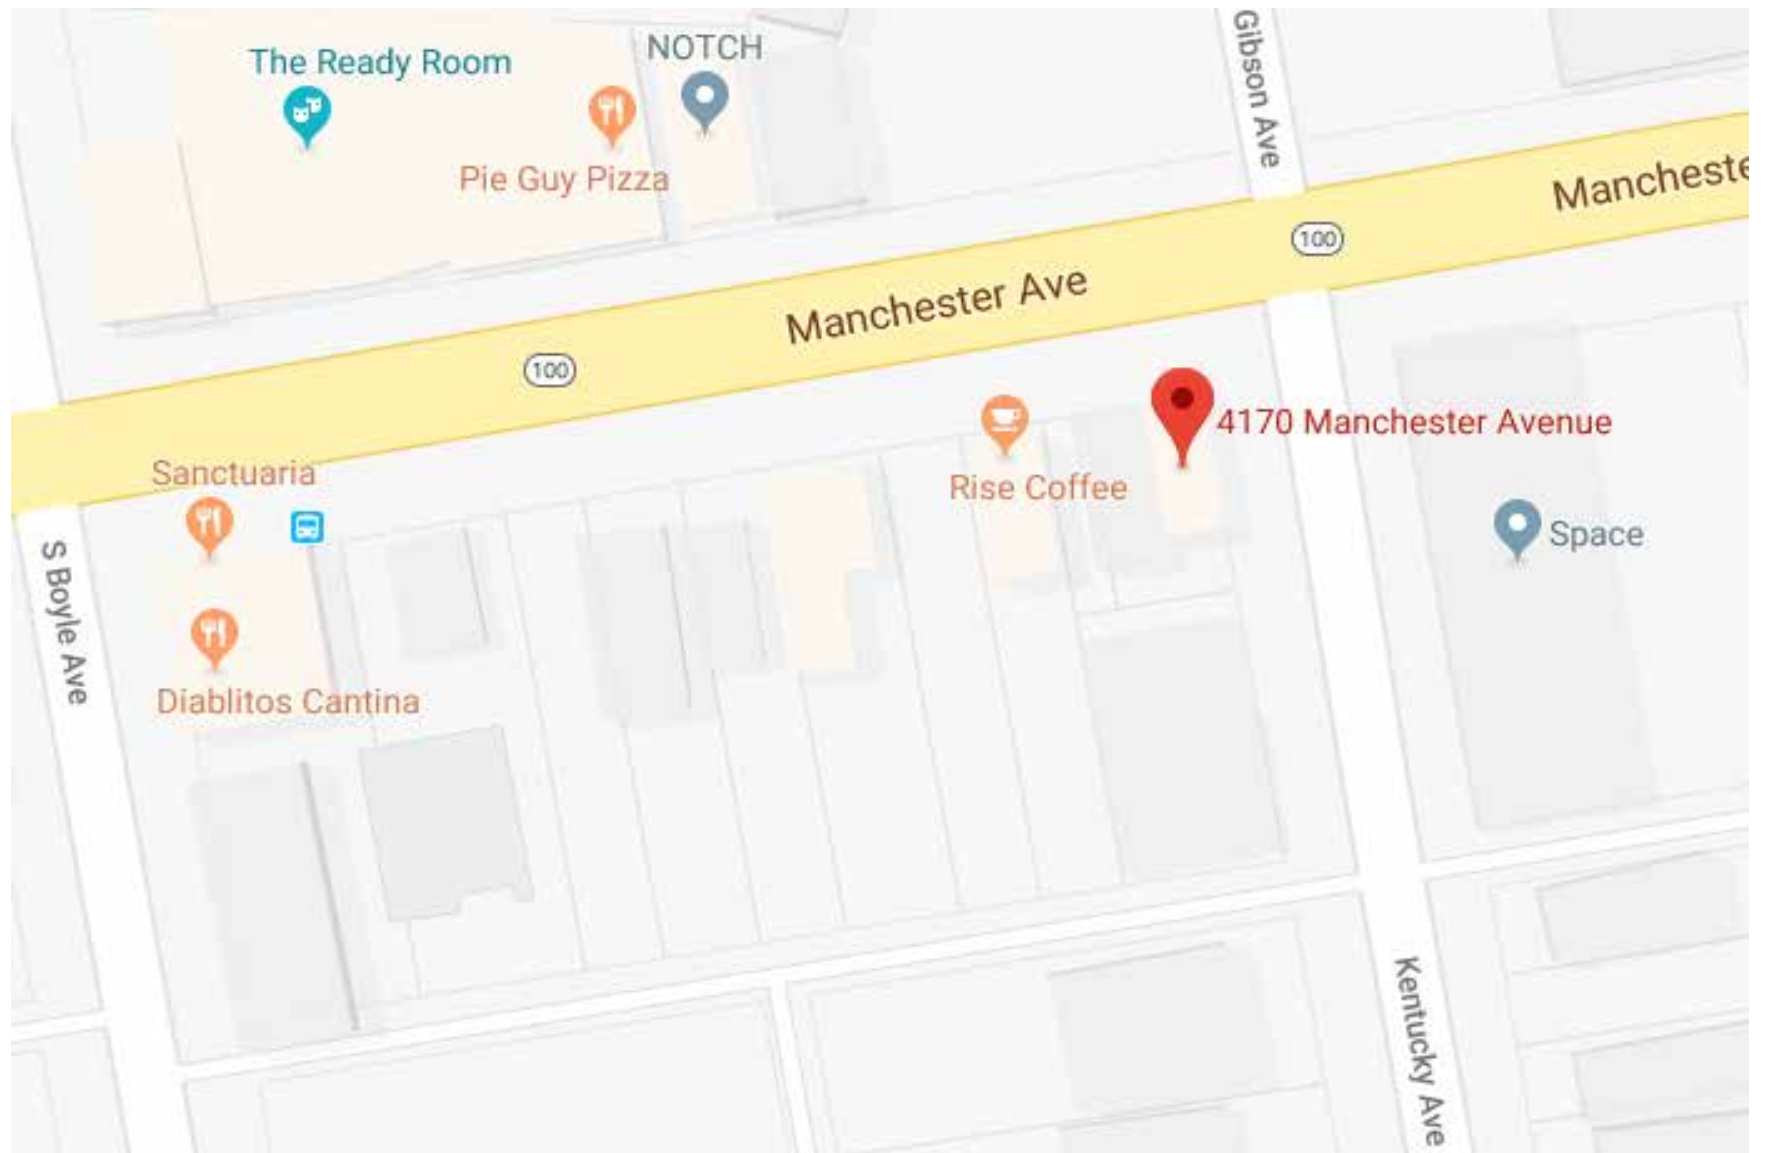



4170 Manchester

### Street View



4170 Manchester

Street View



2/19/2019 9:58:06 AM

D:\Dropbox (V Three Studios)\V Three Studios Team Folder\_Arch\2016\16042\_Bartzel Grove  
Parlor01\_model\lrm\16042\_2019\_0115\_NO CANOPY.rvt

General  
Contractor:

Civil  
Engineer:

Structural  
Engineer:

MEPF  
Engineer:

The Professional Architect's seal affixed to this sheet applies only to the material and items shown on this sheet. All drawings, instruments or other documents not exhibiting this seal shall not be considered prepared by this architect, and this architect expressly disclaims any and all responsibility for such plans, drawings or documents not exhibiting this seal.

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MANCHESTER AVE

KENTUCKY AVE

SIGNAGE PERMIT  
**PARLOR PATIO  
STRUCTURE**  
4170 MANCHESTER AVENUE  
ST. LOUIS, MO 63110

No.	Description	Date

Sheet Title:

SITE PLAN

Project Number: \_\_\_\_\_ Sheet Number: \_\_\_\_\_

16042.03


Drawn By: \_\_\_\_\_

Author: \_\_\_\_\_

Issue Date: \_\_\_\_\_


01-15-2019

**A121**

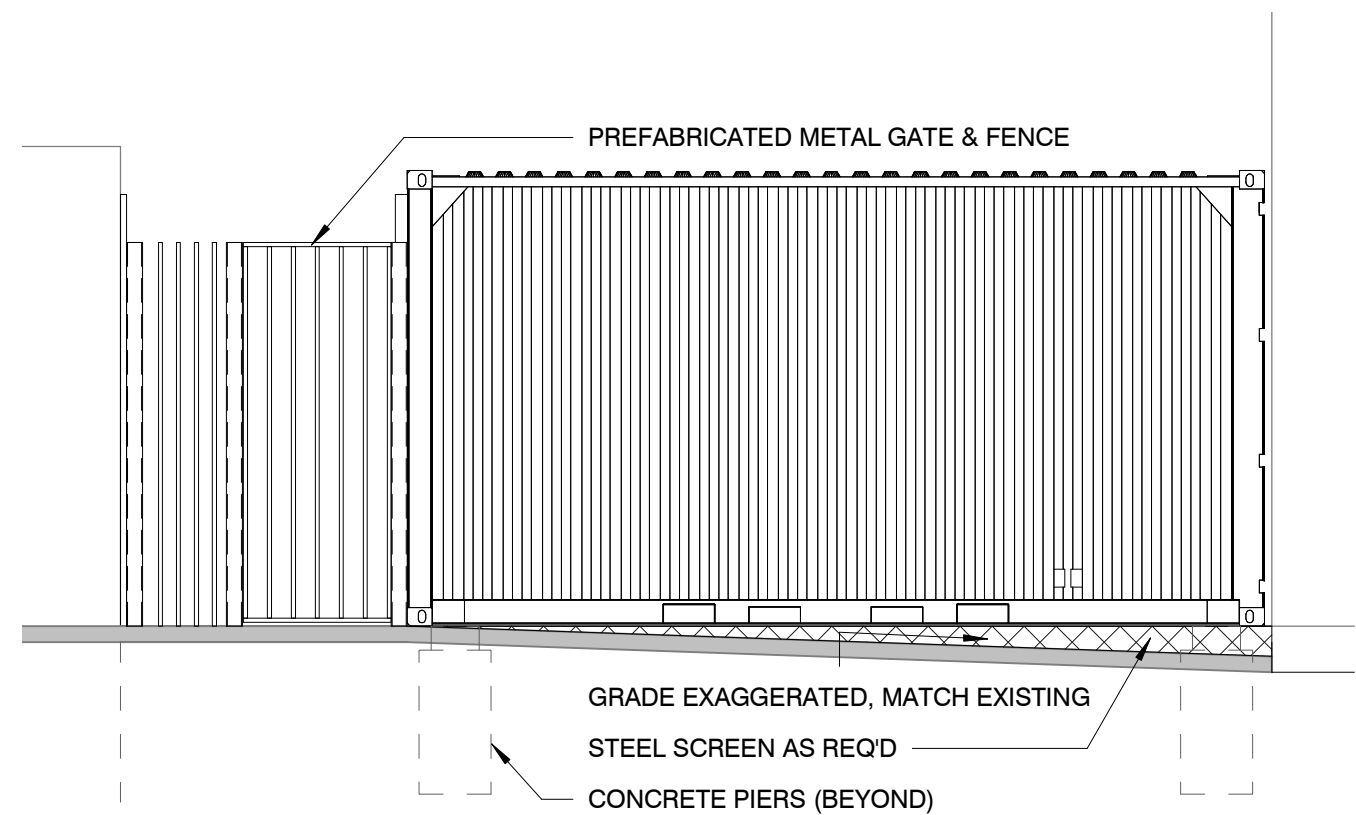


5 CONTAINER ELEVATION @ STREET

A121 1/4" = 1'-0"

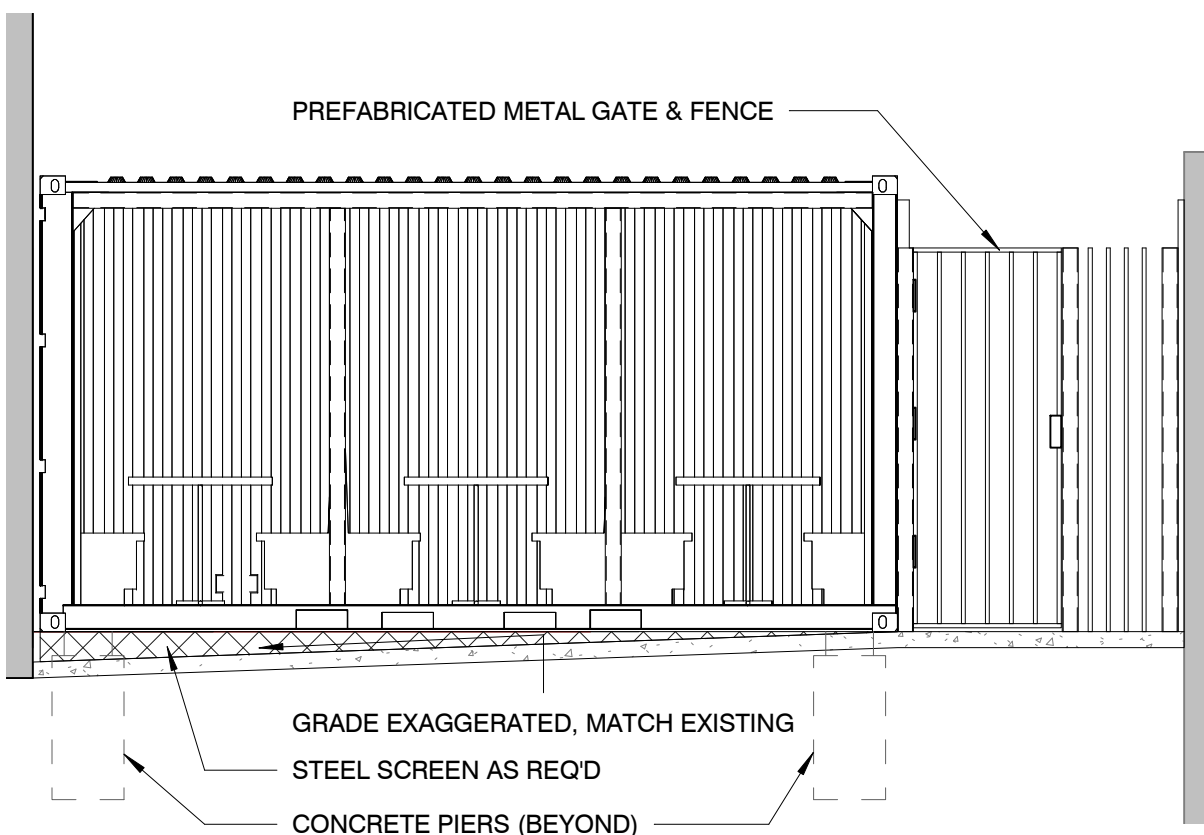


4 CONTAINER ELEVATION @ PATIO

A121 1/4" = 1'-0"

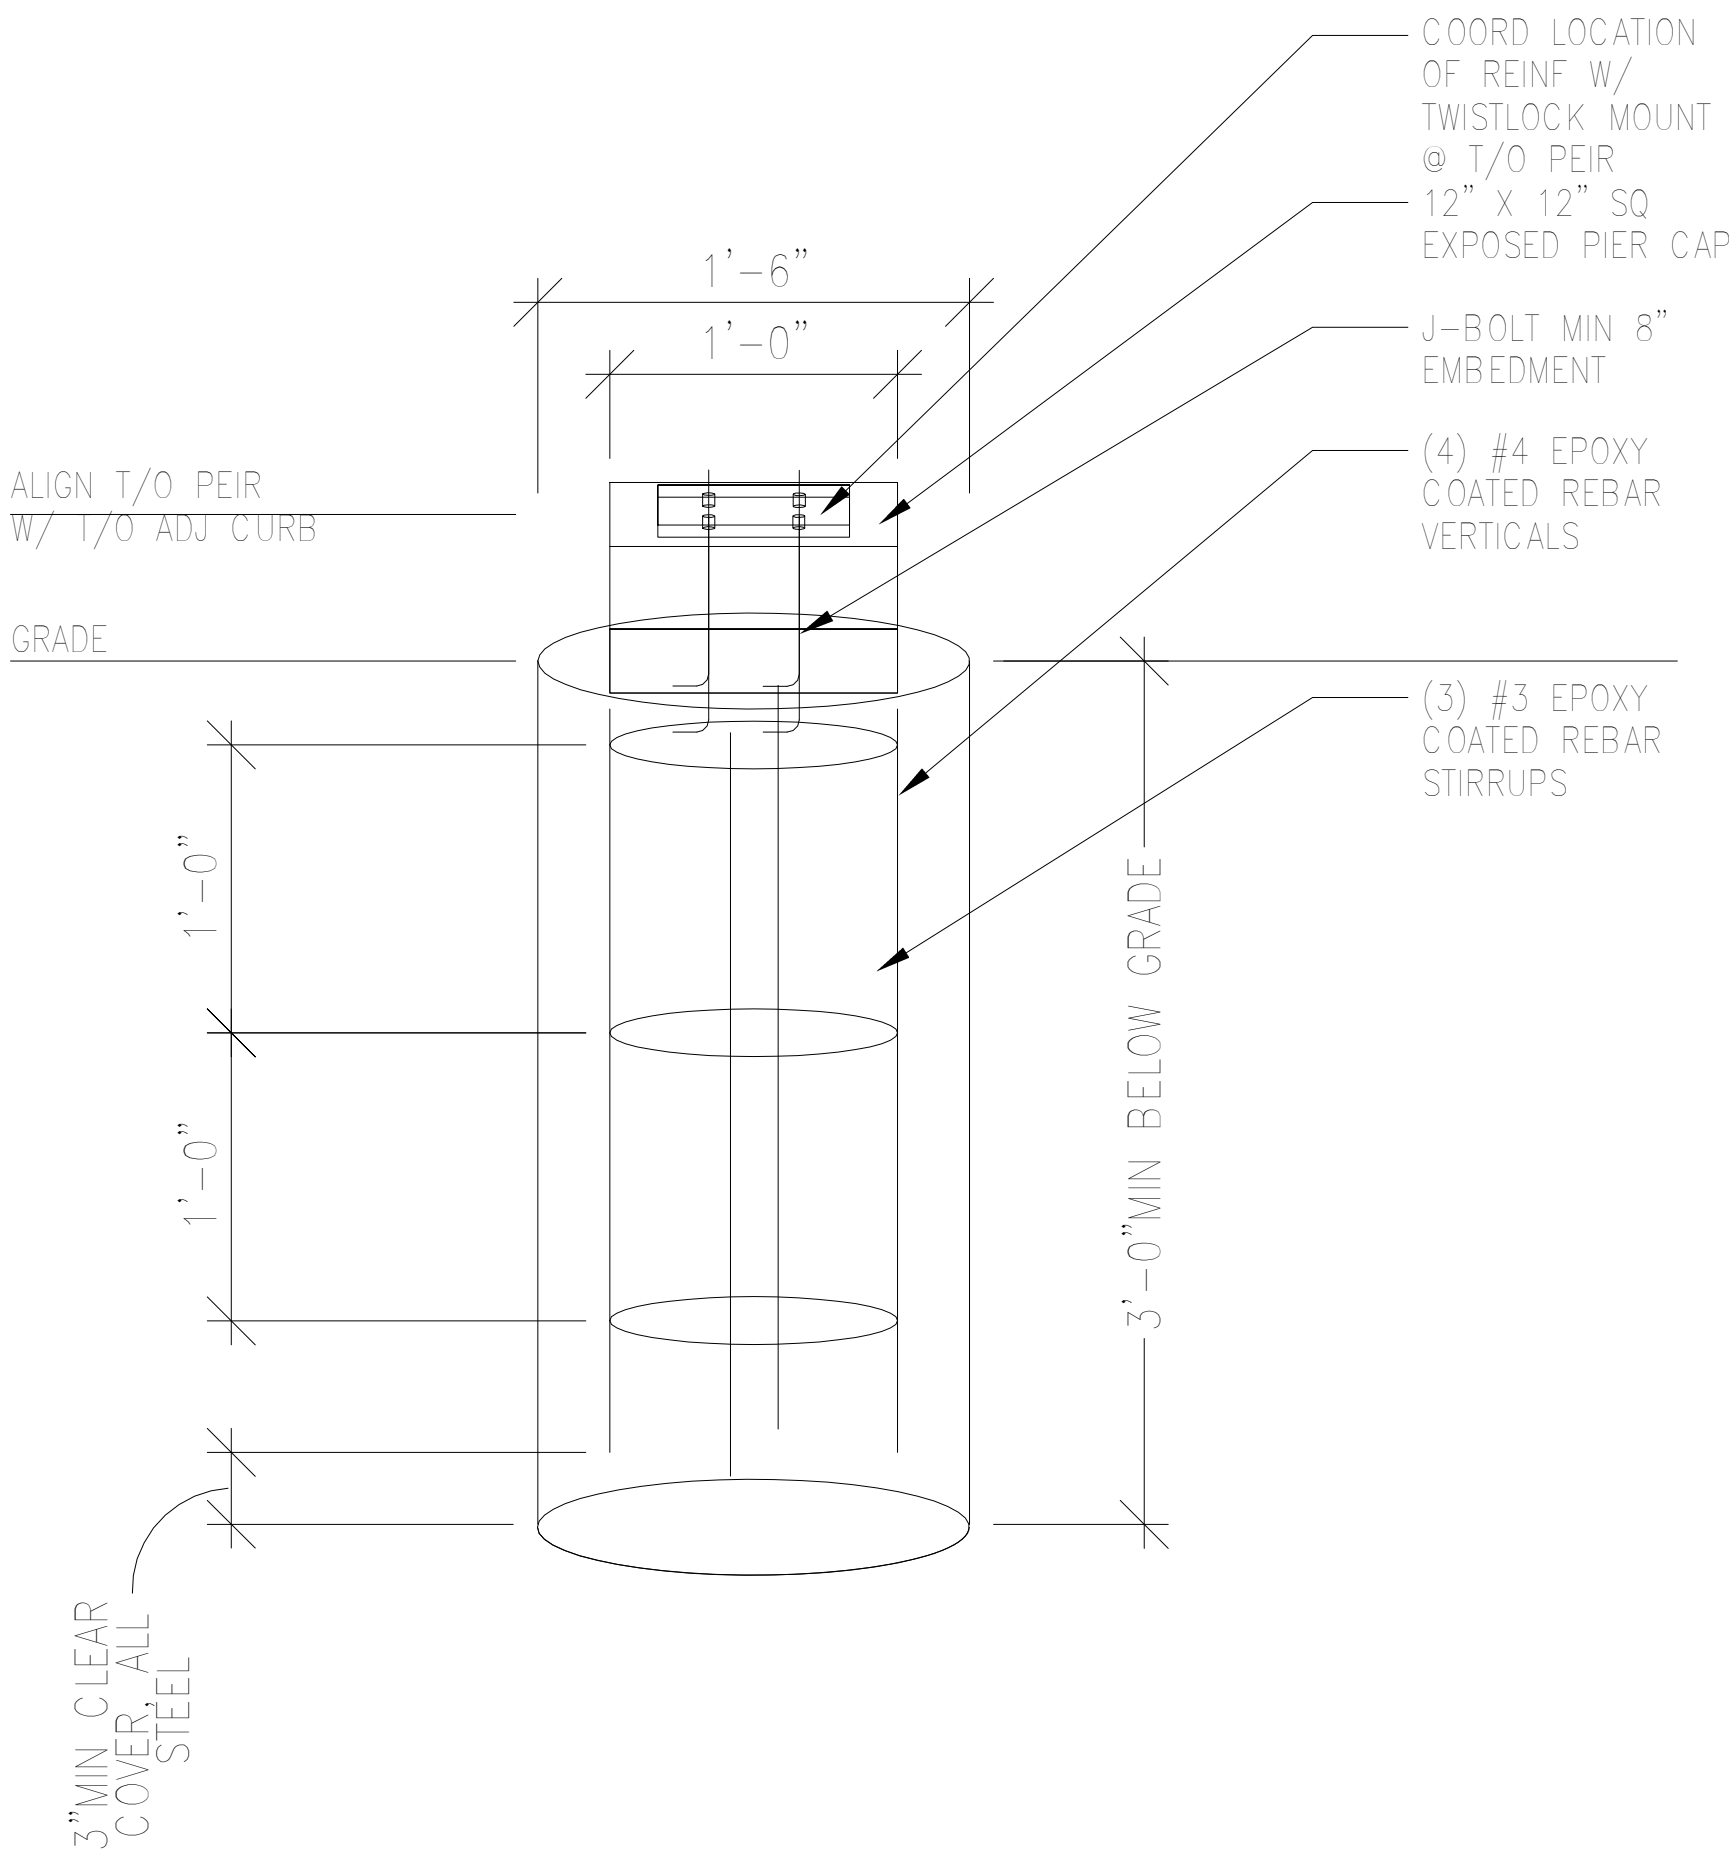


2 TYP DETAIL @ CONCRETE PIER

A121 1 1/2" = 1'-0"

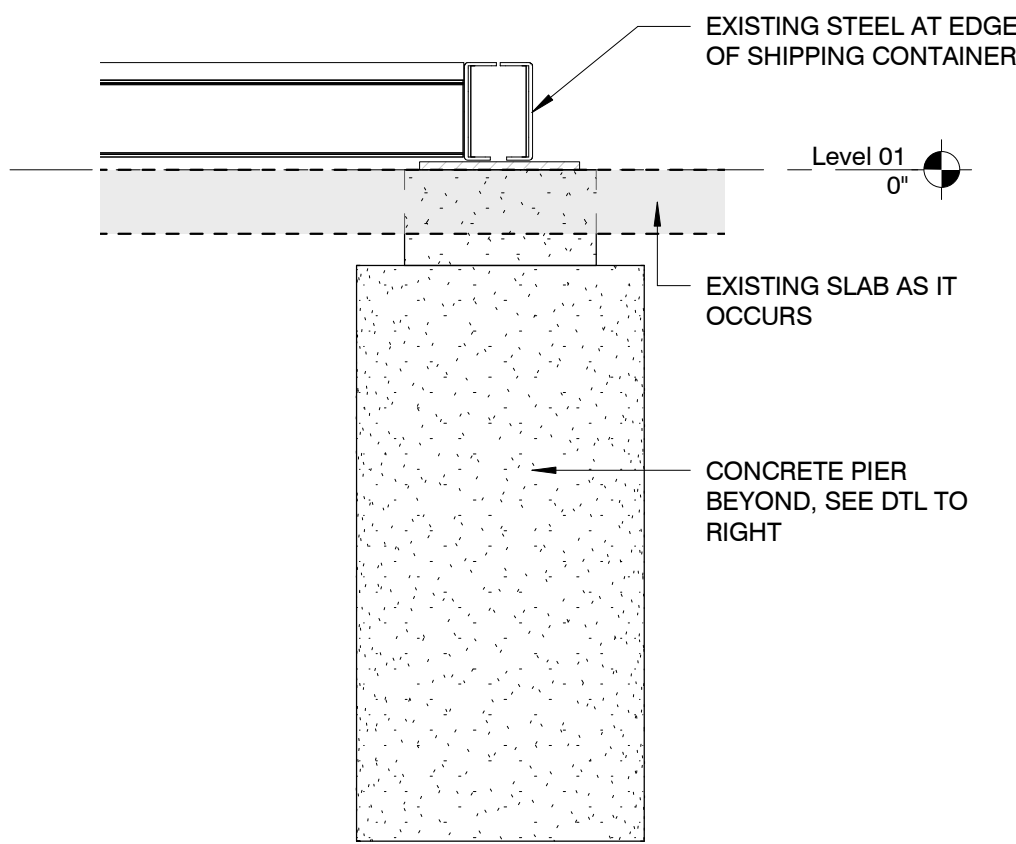


3 CONTAINER STEP

A121 1" = 1'-0"

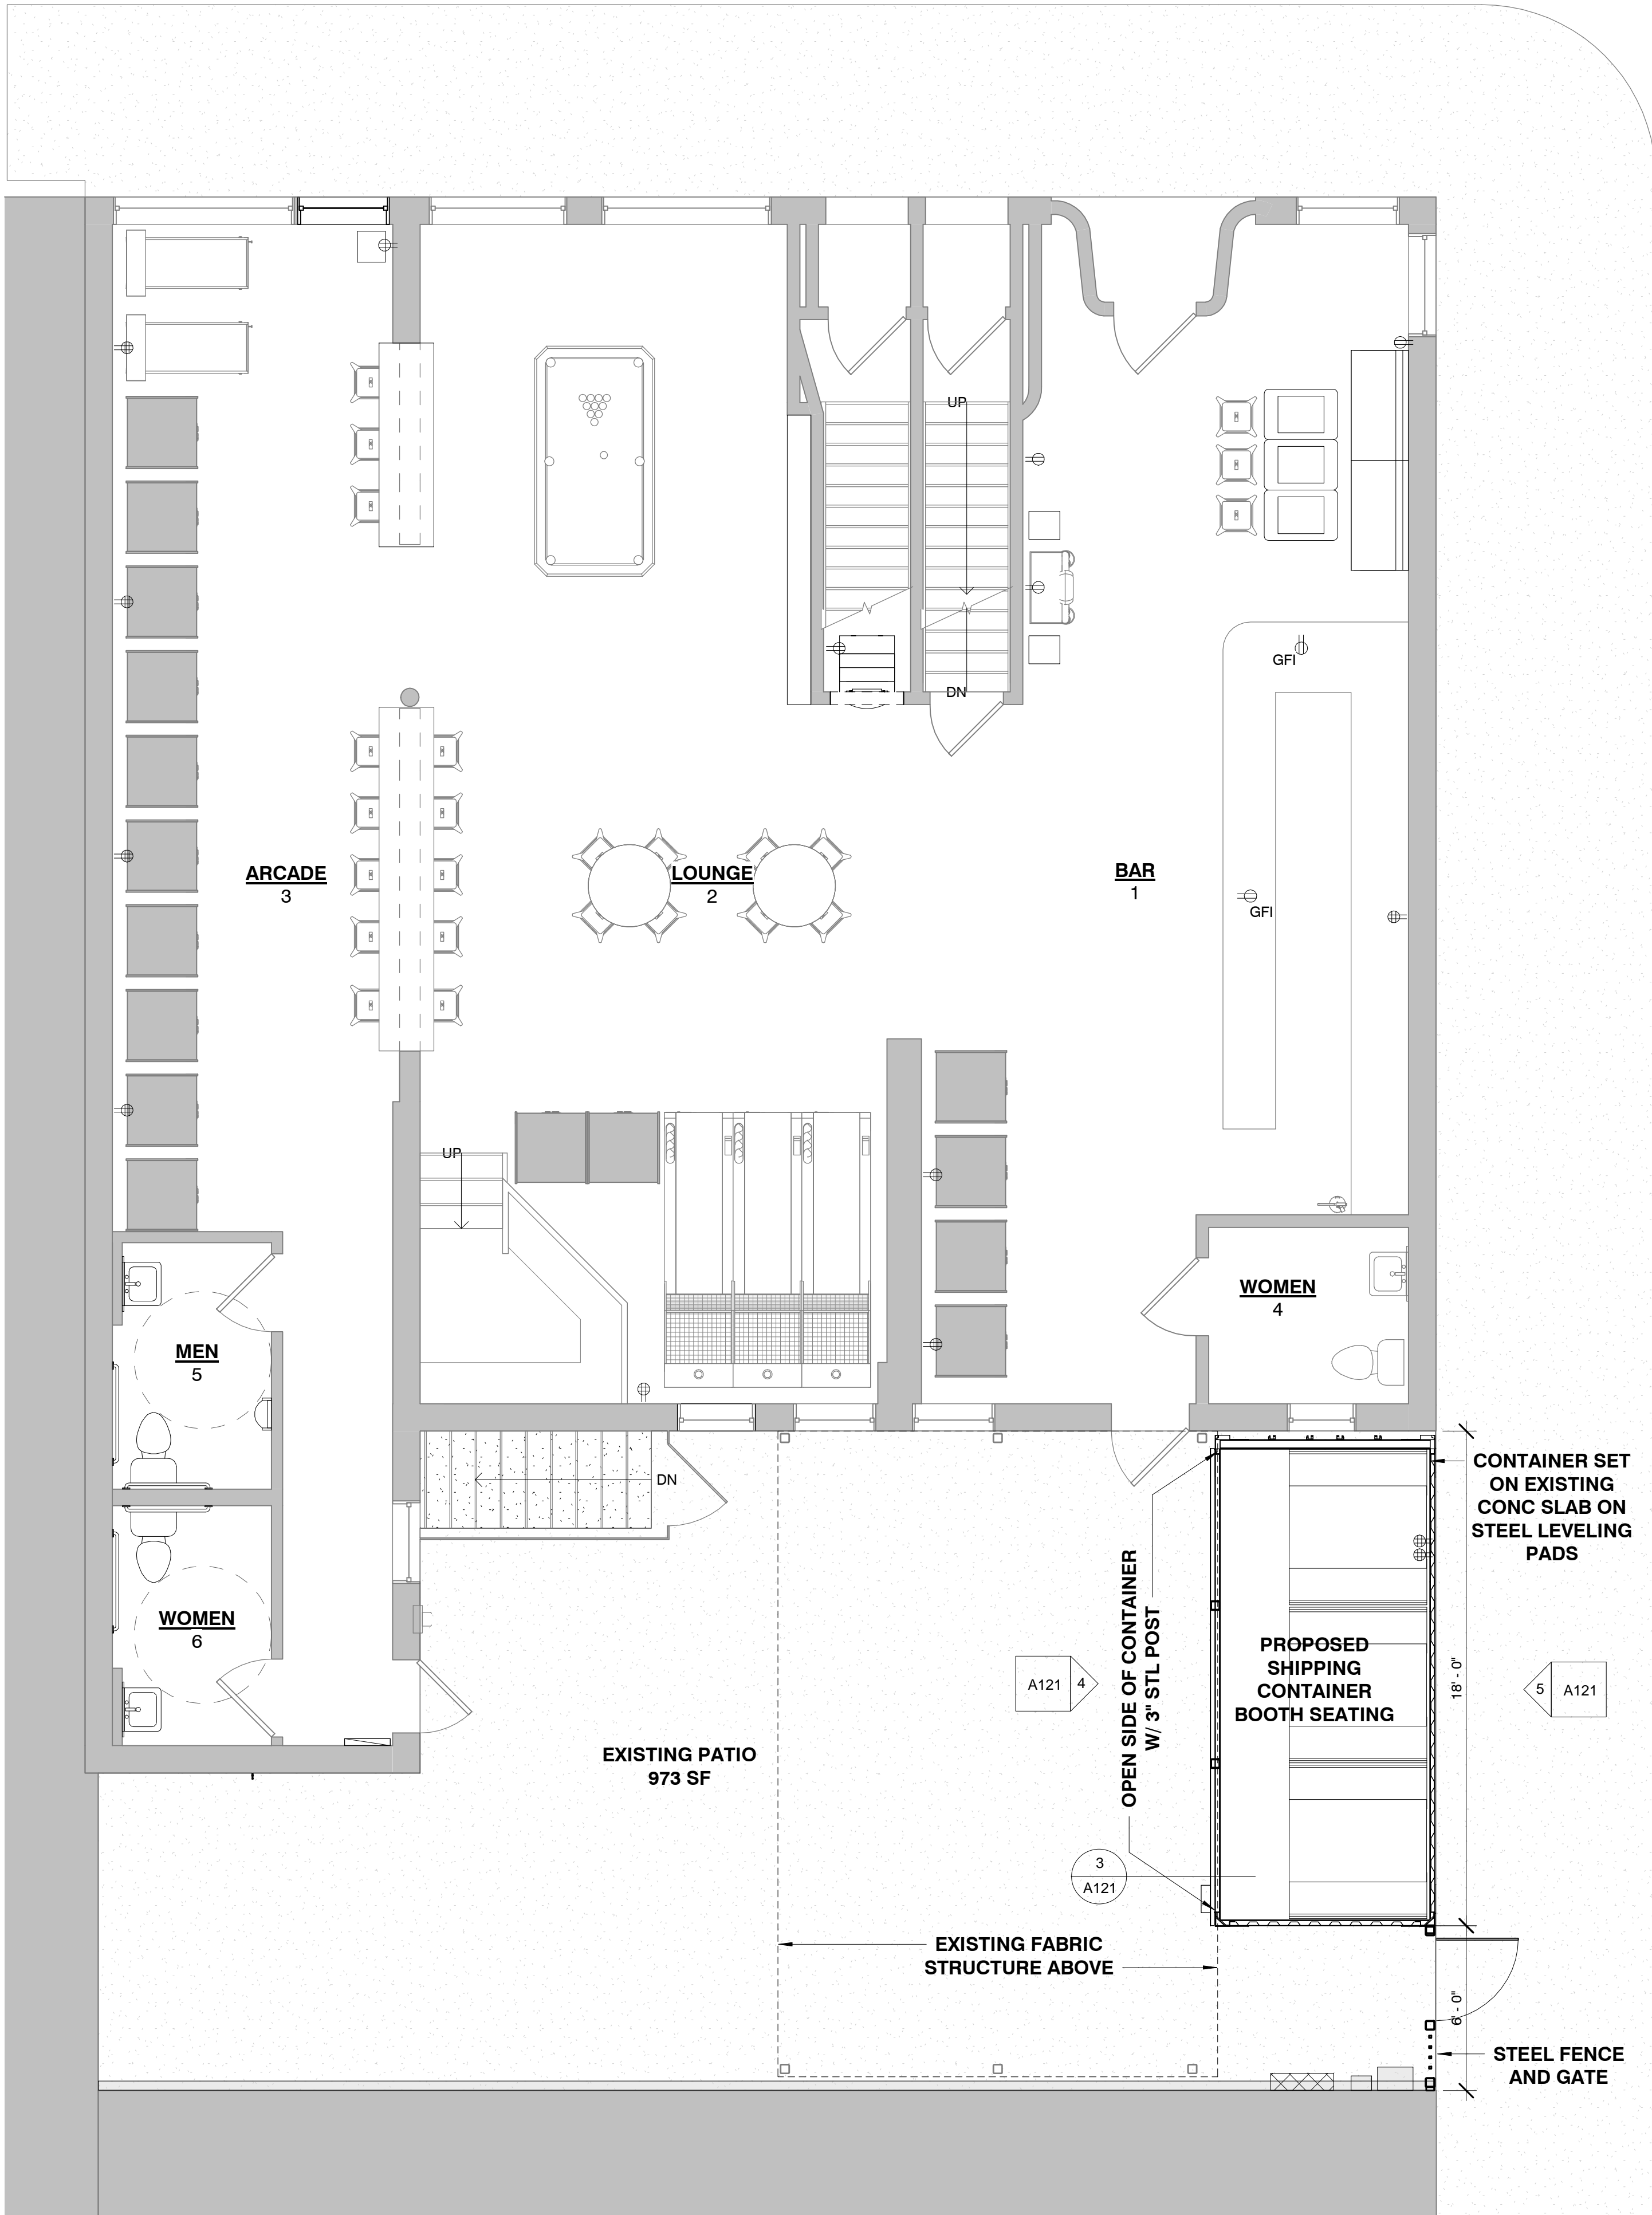

1 SITE PLAN

A121 1/4" = 1'-0"

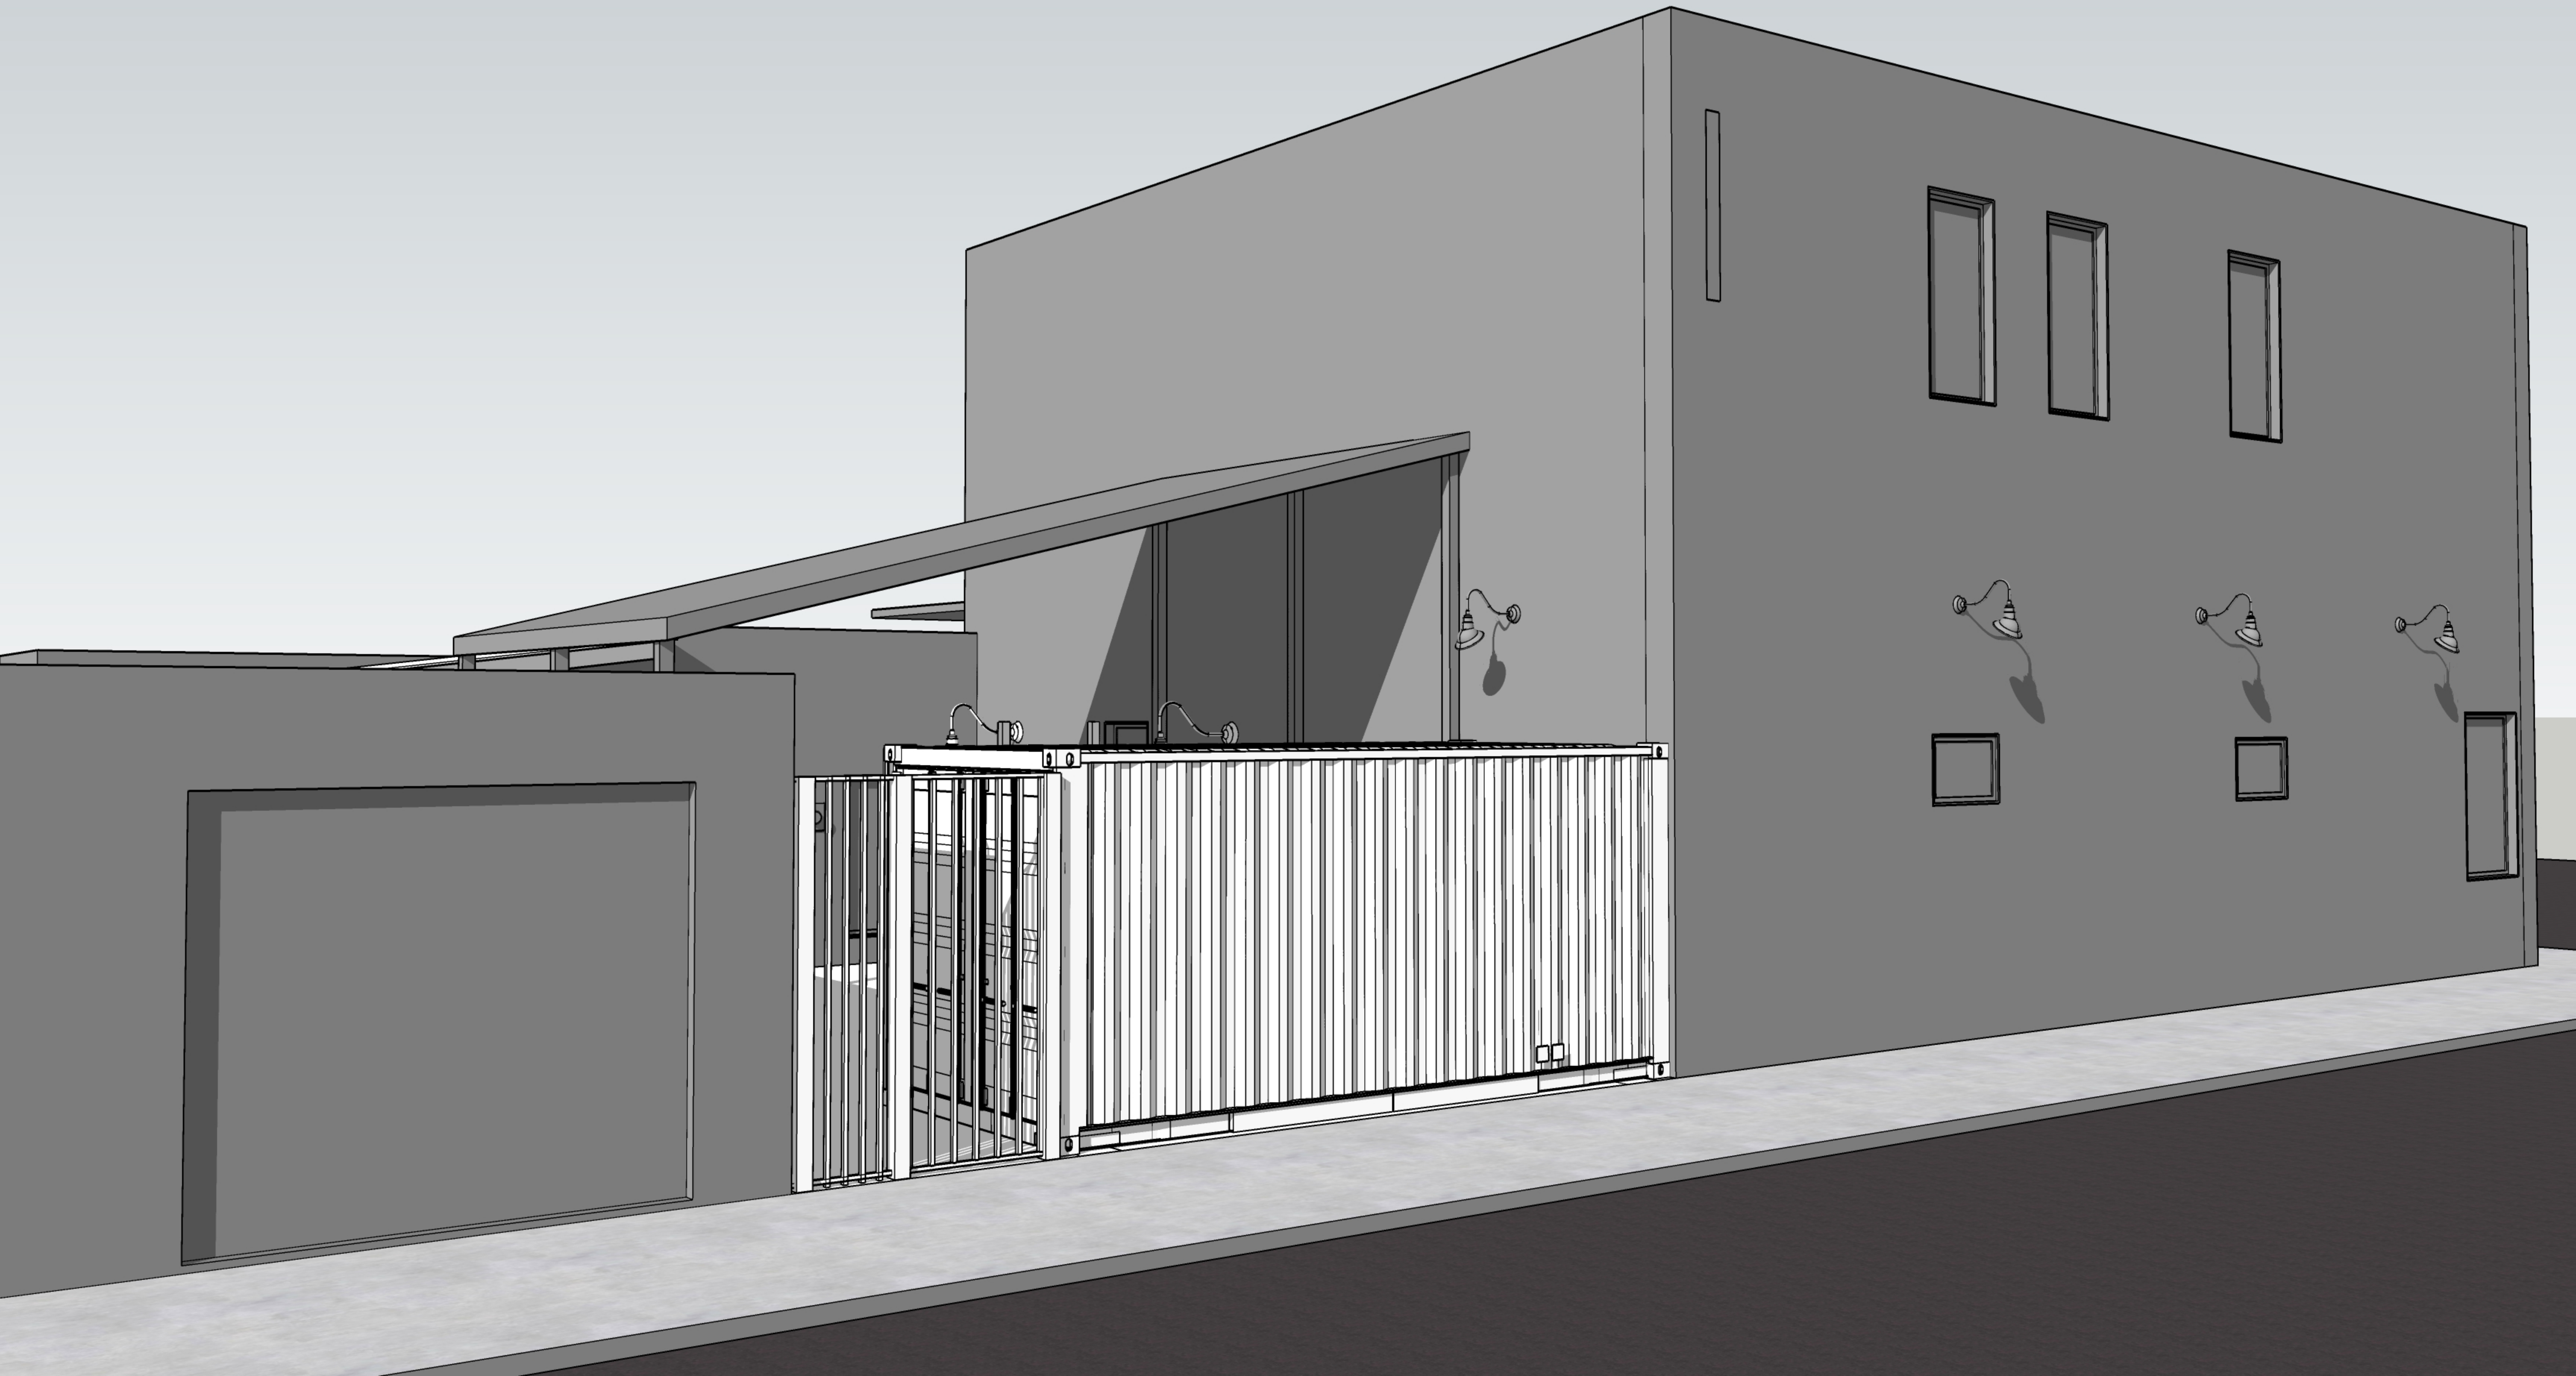

900 South Sarah Street.

**Site Address:** 900 South Sarah Street

**Request:** Community Support for the project and Variances needed as well as Community Feedback

**Company Name:** 4101 Investors LLC.

Contact Person(s): Mark Rubin

**Mailing Address:** 900 Spruce Street, Suite 450, St. Louis, MO 63102

**Company Owners / Principals:** Bill Koman, Phil Hulse, Jason Braidwood, Mark Rubin

### **Project Information**

#### **History of site**

This proposed site was previously platted, Lot 2B of the Commerce Corner Subdivision and served as a parking lot for surrounding businesses for the last several decades. As the first Chroma phase was developed, the parking lot was demolished and remains a vacant undeveloped lot today.

#### **Proposed Project**

Chroma 2 is a compliment to the successful Chroma (first phase) project on the adjacent site. Chroma 2 is planned for 54 apartments (17 studio and 37 one bedroom) and approximately 2200 square feet of commercial area to be constructed on a vacant lot on the southeast corner of Sarah Street and Papin Street. The L-shaped building will wrap an indoor-outdoor amenities area. The addition of commercial space will add services to The Grove neighborhood district for all residents of, and visitors to, the area. Residents of an additional 54 apartments will likewise support businesses in The Grove neighborhood.

#### **Parking**

The project will have two (2) garages, one for each unit. Chroma 2 will utilize existing parking facilities of the first phase. This includes a multi-level parking garage (383 spaces) directly adjacent to Chroma 2 and a surface level parking lot (72 spaces) across Sarah Street. The combined capacity of these two facilities is 455 spaces. All parking garage spaces are hidden from view.

**Current Zoning** Neighborhood Center, Type 1

**Project Costs:**

900 South Sarah Street.

Acquisition:	\$1,500,000
Pre-development Soft Cost:	\$ 2,675,000
Construction Cost:	\$ 6,775,000
Total:	\$ 10,950,000

**Project Timeline:**

Site Control:	Owned by Developer
Construction Start:	May 2019
Construction Complete:	June 2020
Occupancy:	June 2020

**Relevant Experience**

The Koman Group has delivered more than \$1 billion in real estate initiatives, encompassing more than 6 million square feet of commercial and residential space. Additionally, this project is completed in conjunction with the expertise of VE Design Group, a design management firm focusing on mixed use and multi-family developments. VE has completed many similar, successful projects in the St. Louis metropolitan area and throughout the Midwest.

**Will the project seek financial incentives from the City of St. Louis?** Both Phase 1 and Phase 2 have already secured tax abatement. The project required a great deal of infrastructure to put in place as well as there are poor soil conditions that required significant ground improvements.

**Park Central Recommendation**

Park Central Development recommends support for the owner’s conditional use with the following conditions:


1. The developer install and coordinate its exterior security cameras and placement of them with the NSI and coordinate the cameras with the FPSE Camera Network.
2. Repair any streets or infrastructure impacted by the project and provide ADA accessible ramps/curbs for all sidewalks within the project property line.

900 South Sarah Street.

3. Communicate with Language Immersion School to coordinate any safety precautions that may impact student arrival and departure.
4. Any additional changes in the specified use, or any additional changes to the project requiring a variance should be brought before the FPSE Development Committee for review.


900 South Sarah Street.

### Map View

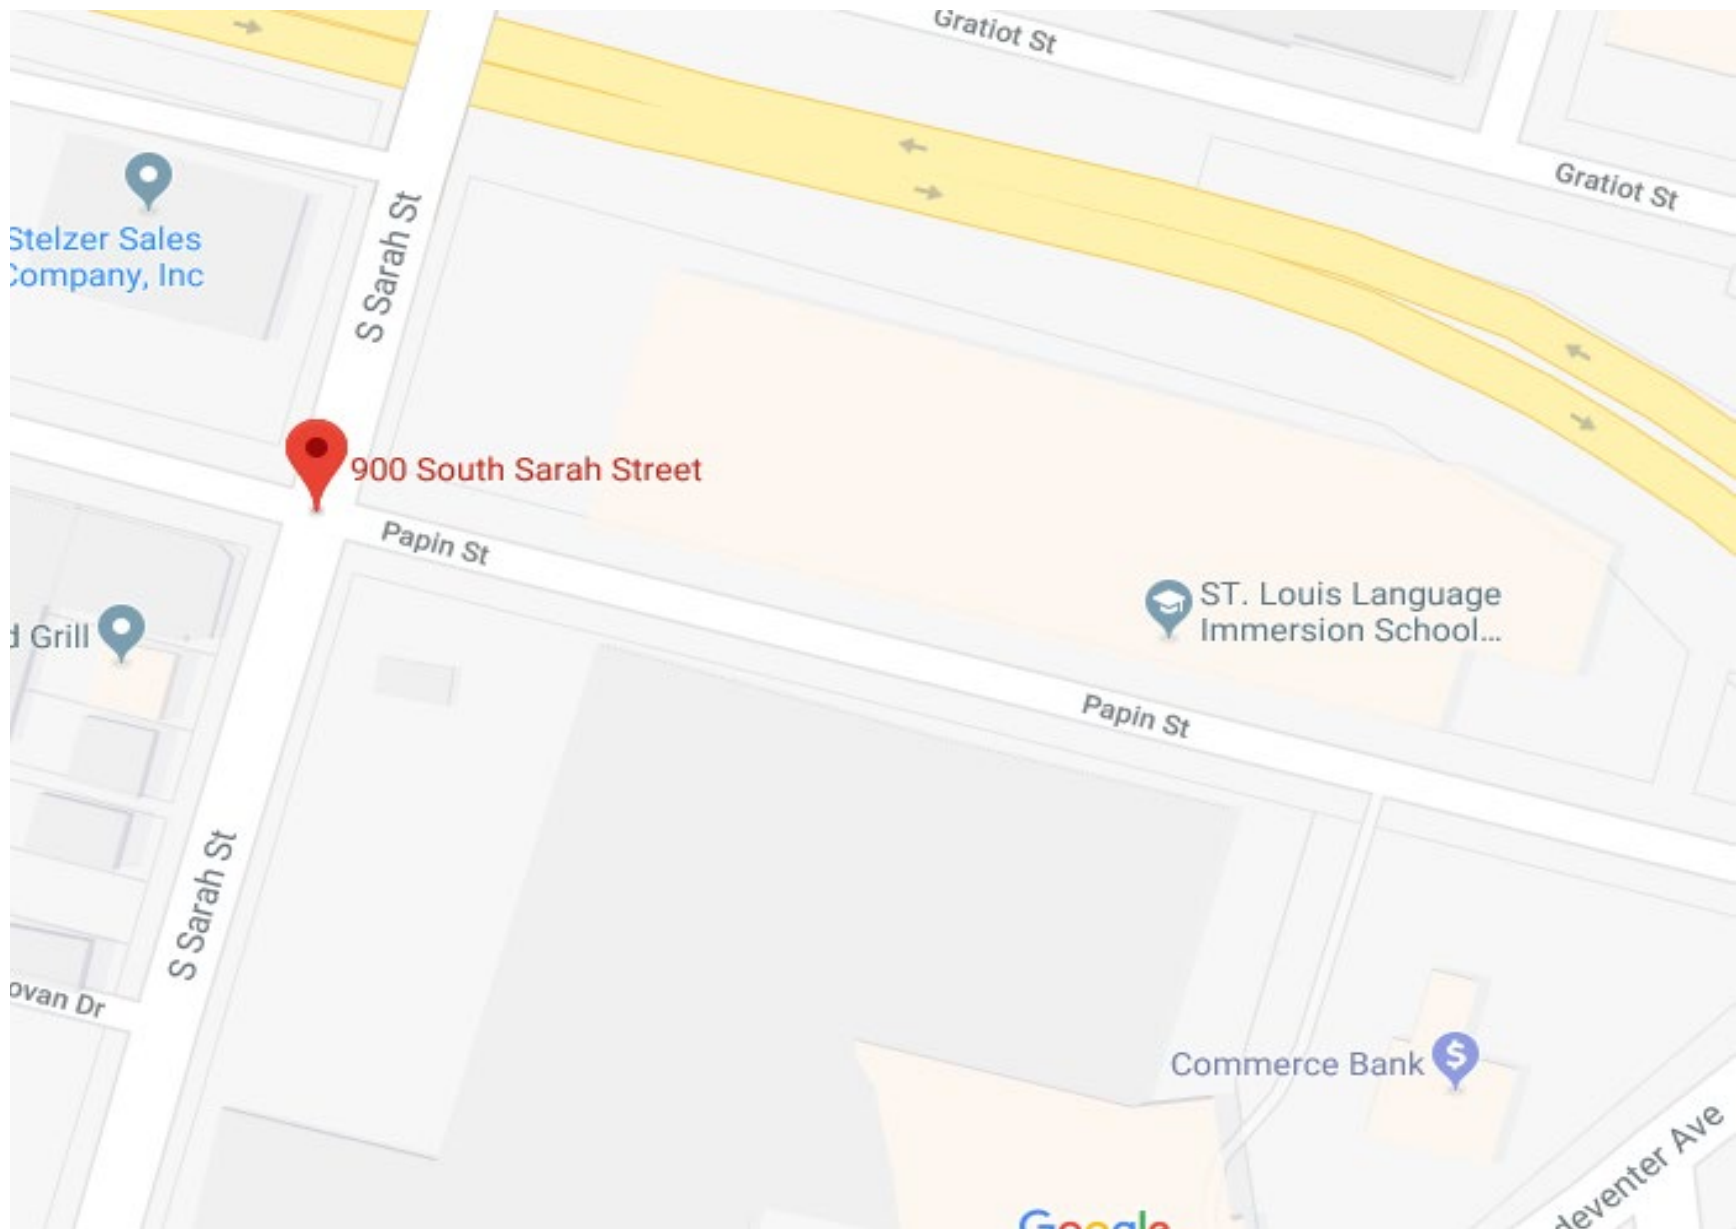

900 South Sarah Street.



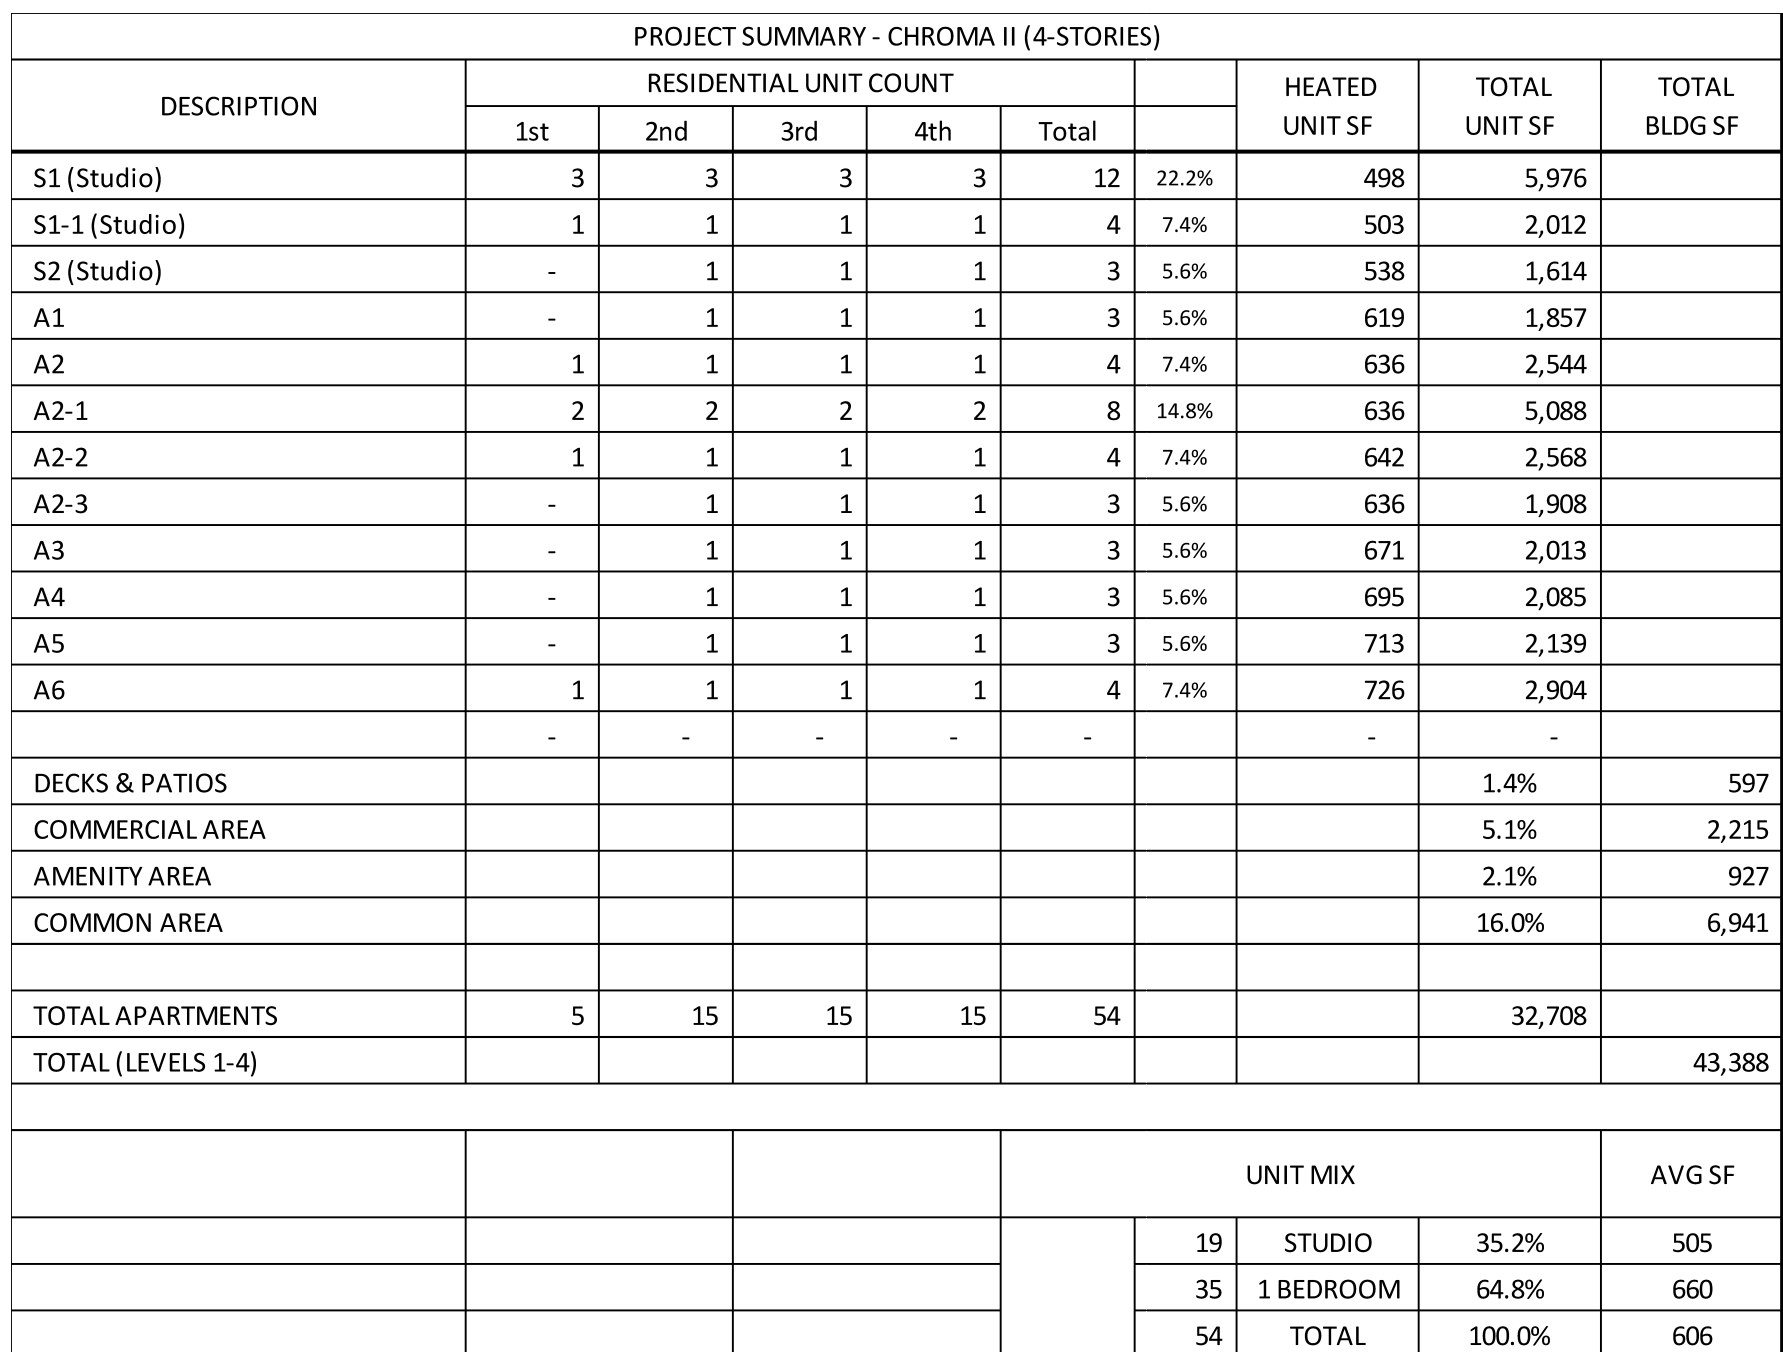

# CHROMA II

MIXED-USE DEVELOPMENT - ST. LOUIS, MO

DESIGN DEVELOPMENT SET

## SHEET INDEX

J1.1 - ENLARGED UNIT PLAN: S1  
J1.2 - ENLARGED UNIT PLAN: S2  
J1.3 - ENLARGED UNIT PLAN: A1  
J1.4 - ENLARGED UNIT PLAN: A2  
J1.5 - ENLARGED UNIT PLAN: A3  
J1.6 - ENLARGED UNIT PLAN: A4  
J1.7 - ENLARGED UNIT PLAN: A5

A2.1 - COLOR ELEVATIONS  
A2.2 - COLOR ELEVATIONS  
A2.3 - COLOR ELEVATIONS  
A2.4 - MATERIAL REF.

AS1.1 - BUILDING SECTION  
AS4.1 - FRAMING DETAILS


ARCHITECT  
VE DESIGN GROUP, LLC.  
520 E JACKSON STREET, SUITE 2  
WILLARD, MO 65781  
PHONE: 417.612.2913

GENERAL CONTRACTOR  
KOMAN GROUP  
900 SPRUCE STREET, SUITE 450  
ST. LOUIS, MO 63102

CIVIL ENGINEER  
POEHLMAN & PROST, INC  
46 C WORTHINGTON ACCESS DRIVE  
MARYLAND HEIGHTS, MO 63043  
PHONE: 314.997.5777

CODE COMPLIANCE	
BUILDING CODES:	2018 IBC WITH CITY OF ST. LOUIS, MO AMENDMENTS 2018 INTERNATIONAL ENERGY CONSERVATION CODE
USE GROUPS:	R-2 & A-3
BUILDING HEIGHTS & AREAS:	REFER TO G1 SHEETS
TYPE OF CONSTRUCTION:	TYPE V-A
FIRE RATED ASSEMBLIES:	REFER TO G2 SHEETS
SPRINKLER SYSTEM:	FULLY SPRINKLED (NFPA 13)
MEANS OF EGRESS:	REFER TO G3 SHEETS
ACCESSIBILITY:	A117.1-2009 REFER TO SHEETS G4.1 - G4.2

04/11/19 CULTURAL  
RESOURCES SUBMITTAL  
(NOT FOR CONSTRUCTION)

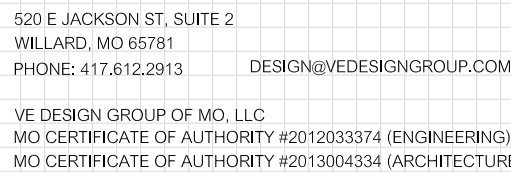

## ST. LOUIS, MO

DRAWING TITLE

COVER

PROJECT #	DRAWING NUMBER
850	<h1>TITLE</h1> <h2>DESIGN DEVELOPMENT</h2>
DATE	
04/11/19	





**N**  
SITE LAYOUT  
Scale: 1" = 30'-0"

**VE**  
**DESIGN GROUP**

520 E JACKSON ST., SUITE 2  
WILLARD, MO 65781  
PHONE: 417.612.2913  
DESIGN@VEDESIGNGROUP.COM  
VE DESIGN GROUP OF MO, LLC  
MO CERTIFICATE OF AUTHORITY #2012030374 (ENGINEERING)  
MO CERTIFICATE OF AUTHORITY #2013004334 (ARCHITECTURE)

**CHROMA II**  
**MIXED-USE DEVELOPMENT**  
(CONCEPT 2.3)

ST. LOUIS, MO

NO	REVISIONS	DATE

DRAWING TITLE  
**SITE LAYOUT 2.3**

PROJECT # <b>850</b>	DRAWING NUMBER <b>G0.2</b>
DATE <b>02/22/19</b>	DESIGN DEVELOPMENT

UNIT DOOR SCHEDULE												
	KEY (#)	SIZE	TYPICAL LOCATION (UNO)	LEVEL	DOOR DESCRIPTION	FRAME DESC.	FIRE RATING (MIN)	BRG HEADER SIZE, GRADE & SPECIES	TRIMMERS @ BRG HEADERS (EA END)			HARDWARE SET
								2x6 WALL / 2x4 WALL	2 FLOORS ABOVE	1 FLOOR ABOVE	0 FLOORS ABOVE	
UNIT INTERIOR	11	-	-	-	-	-	-	-	-	-	-	-
	12	2068	COAT	ALL	HC MASONITE	PH	-	(3) 2x8 #2 SYP or (2) 2x10 #2 SYP	2	1	1	-
	13	2468	COAT / MECHANICAL	ALL	HC MASONITE	PH	-	(3) 2x8 #2 SYP or (2) 2x10 #2 SYP	2	1	1	-
	14	-	-	-	-	-	-	-	-	-	-	-
	15	-	-	-	-	-	-	-	-	-	-	-
	16	21068	BEDROOM & BATH ENTRY / LAUNDRY	ALL	HC MASONITE	PH	-	(3) 2x8 #2 SYP or (2) 2x10 #2 SYP	2	1	1	-
	17	21068	BATH ENTRY POCKET DOOR	ALL	HC MASONITE	PH	-	(3) 2x6 #2 SYP (SEE 9/U4.3)	2	1	1	-
UNIT INTERIOR	21	(2) 1668	WALK-IN CLOSETS / LAUNDRY	ALL	HC MASONITE	PH	-	(3) 2x8 #2 SYP or (2) 2x10 #2 SYP	2	1	1	-
	22	(2) 2068	WALK-IN CLOSETS	ALL	HC MASONITE	PH	-	(3) 2x8 #2 SYP or (2) 2x10 #2 SYP	2	1	1	-
	23	-	-	-	-	-	-	-	-	-	-	-
	24	-	-	-	-	-	-	-	-	-	-	-
	25	-	-	-	-	-	-	-	-	-	-	-
	26	-	-	-	-	-	-	-	-	-	-	-
	27	-	-	-	-	-	-	-	-	-	-	-
UNIT INTERIOR	31	-	-	-	-	-	-	-	-	-	-	-
	32	-	-	-	-	-	-	-	-	-	-	-
	33	-	-	-	-	-	-	-	-	-	-	-
	34	-	-	-	-	-	-	-	-	-	-	-
	35	-	-	-	-	-	-	-	-	-	-	-
	36	-	-	-	-	-	-	-	-	-	-	-
	37	-	-	-	-	-	-	-	-	-	-	-
UNIT INT	41	-	-	-	-	-	-	-	-	-	-	-
	42	-	-	-	-	-	-	-	-	-	-	-
	43	-	-	-	-	-	-	-	-	-	-	-
UNIT ENTRY	51	3068	UNIT ENTRY	ALL	HM	HM	20	(3) 2x10 #2 SYP	2	1	1	1
	52	-	-	-	-	-	-	-	-	-	-	-
	53	6080	PATIO / BALCONY	ALL	SLIDING GLASS W/ SDL	VINYL	-	(3) 2x10 #2 SYP	2	1	1	3
	54	9080	PATIO / BALCONY	ALL	SLIDING GLASS W/ SDL	VINYL	-	(3) 2x10 #2 SYP	2	1	1	3
	55	-	-	-	-	-	-	-	-	-	-	-
	56	-	-	-	-	-	-	-	-	-	-	-
	57	-	-	-	-	-	-	-	-	-	-	-
	58	-	-	-	-	-	-	-	-	-	-	-
	59	-	-	-	-	-	-	-	-	-	-	-
	60	-	-	-	-	-	-	-	-	-	-	-
	-	-	-	-	-	-	-	-	-	-	-	-

WINDOW SCHEDULE												
	KEY (#)	SIZE	LOCATION	LEVEL	WINDOW DESCRIPTION	FRAME DESC.	FIRE RATING (MIN)	HEADER HEIGHT (UNO)	BRG HEADER SIZE, GRADE & SPECIES	TRIMMERS @ BRG HEADERS (EA END)		
										2 FLOORS ABOVE	1 FLOOR ABOVE	0 FLOORS ABOVE
EXTERIOR	A	2860	VARIOUS UNITS	ALL	SINGLE HUNG w/SDL	VINYL	-	8'-0 7/8"	(3) 2x10 #2 SYP	2	1	1
	B	3060	VARIOUS UNITS	ALL	SINGLE HUNG w/SDL	VINYL	-	8'-0 7/8"	(3) 2x10 #2 SYP	2	1	1
	Bf	3060	STAIRS	ALL	PICTURE w/SDL	VINYL	-	8'-0 7/8"	(3) 2x10 #2 SYP	2	1	1
	C	(2) 2846	VARIOUS UNITS	ALL	SINGLE HUNG w/SDL	VINYL	-	8'-0 7/8"	(3) 2x10 #2 SYP	2	1	1
	D	(2) 2850	VARIOUS UNITS	ALL	SINGLE HUNG w/SDL	VINYL	-	6'-10 1/4"	(3) 2x10 #2 SYP	2	1	1
	E	(2) 2860	VARIOUS UNITS	ALL	SINGLE HUNG w/SDL	VINYL	-	8'-0 7/8"	(3) 2x10 #2 SYP	2	1	1
	F	(2) 3050	VARIOUS UNITS	ALL	SINGLE HUNG w/SDL	VINYL	-	6'-10 1/4"	(3) 2x10 #2 SYP	2	1	1
	G	(2) 3060	VARIOUS UNITS	ALL	SINGLE HUNG w/SDL	VINYL	-	8'-0 7/8"	(3) 2x10 #2 SYP	2	1	1
	Gf	(2) 3060	CORRIDOR	ALL	PICTURE w/SDL	VINYL	-	8'-0 7/8"	(3) 2x10 #2 SYP	2	1	1
	H	1854	VARIOUS UNITS	ALL	TRANSOM w/SDL	VINYL	-	9'-0 1/4"	(3) 2x10 #2 SYP	2	1	1
	J	1860	VARIOUS UNITS	ALL	TRANSOM w/SDL	VINYL	-	9'-0 1/4"	(3) 2x10 #2 SYP	2	1	1

DOOR & WINDOW SCHEDULE NOTES:

1. WINDOW HEADER HEIGHTS SHOWN ABOVE ARE TYPICAL. WINDOWS WITH NON-TYPICAL HEADER HEIGHTS ARE DIMENSIONED ON FRAMING ELEVATIONS.
2. OPERABLE WINDOWS WITH SILL HEIGHTS LESS THAN 36" ARE REQUIRED TO USE WINDOW OPENING CONTROL DEVICES PER IBC 1015.8.1.
3. KING STUDS AND TRIMMERS SHALL MEET OR EXCEED STUD SPECIFICATIONS FOR THE WALL IN WHICH THEY OCCUR.
4. AT OPENINGS IN INTERIOR NON-BEARING WALLS, PROVIDE (1) 2x KING STUD & (1) 2x TRIMMER (EA END).
5. AT OPENINGS IN INTERIOR LOAD-BEARING WALLS, PROVIDE (1) 2x KING STUD (EA END) AND REFER TO SCHEDULE ABOVE FOR REQUIRED NUMBER OF TRIMMERS.
6. AT OPENINGS IN EXTERIOR WALLS, PROVIDE (1) 2x6 KING STUD FOR OPENINGS 5'-0" OR LESS, (2) 2x6 KING STUDS FOR OPENINGS GREATER THAN 5'-0" AND LESS THAN 10'-6" AND REFER TO SCHEDULE ABOVE FOR REQUIRED NUMBER OF TRIMMERS.
7. ALL OPENINGS IN RATED WALLS SHALL HAVE A MINIMUM OF (3) 2x MEMBERS TOTAL AT EACH END TO SATISFY THE 1-HR FIRE RATING. IF THE TOTAL SPECIFIED NUMBER OF KING STUDS AND TRIMMERS IS LESS THAN (3) AT EACH END, PROVIDE ADDITIONAL MEMBERS.
8. AT ALL LOAD BEARING OPENINGS, FLOOR SYSTEMS SHALL BE FULLY BLOCKED WITH AN EQUAL NUMBER OF 2x MEMBERS AS REQUIRED FOR THE OPENING ABOVE THE FLOOR CAVITY.
9. HEADERS IN BEARING WALLS SHALL BE FULLY SHIMMED TO MATCH WALL THICKNESS.
10. SEE FRAMING ELEVATIONS FOR WINDOWS & DOORS REQUIRED TO HAVE SAFETY GLAZING (TEMPERED GLASS) PER IBC SECTION 2406.4.
11. WINDOWS/GLAZING SHALL MEET OR EXCEED THE FOLLOWING CRITERIA:

DESIGN PRESSURE (DP) = 25 PSF (MIN)

THERMAL TRANSMITTANCE 'U' FACTOR = 0.34 (MAX)

SOLAR HEAT GAIN COEFFICIENT (SHGC) = 0.40 (MIN)
12. ABBREVIATIONS:









HM=HOLLOW METAL

PH=PRE-HUNG WOOD

HC=HOLLOW CORE MASONITE

AL=ALUMINUM STORE FRONT

SDL=SIMULATED DIVIDED LIGHT

BEARING WALL STUD & PLATE SCHEDULE															
STUD SPECIFICATIONS			2x4 WALL CAPACITY (PLF)				2x6 WALL CAPACITY (PLF)				2x4/2x6 PLATES - SPECIES & GRADE				
KEY	SPECIES & GRADE	SPACING	KEY COLOR	9'-1 1/8"		10'-1 1/8"		KEY COLOR	9'-1 1/8"		10'-1 1/8"		BOTTOM		DOUBLE TOP PLATE
				INTERIOR	EXTERIOR	INTERIOR	EXTERIOR		INTERIOR	EXTERIOR	INTERIOR	EXTERIOR	BSMT/LEVEL 1	LEVEL 2-4	
A	SPF STUD	16" OC		1365	690	1140	455		3290	3290	3255	2555	#2 / ACQ	#2 / SPF	#2 / SPF
B	SPF STUD	12" OC		1820	1100	1525	780		4720	4385	4340	3760	#2 / ACQ	#2 / SPF	#2 / SPF
C	SPF STUD	2@16" OC		2730	1970	2285	1480		5945	5945	5945	5945	#2 / ACQ	#2 / SPF	#2 / SPF
D	#2 SPF	2@16" OC		3370	2675	2770	2055		5945	5945	5945	5945	#2 / ACQ	#2 / SPF	#2 / SPF

SEE SHEAR WALL PLANS FOR REQUIRED WALL SHEATHING & FASTENING

BEAM SCHEDULE			
KEY	DESCRIPTION	KEY	DESCRIPTION
1	(3) 2x6 #2 SYP	2	(2) 2x6 #2 SYP
3	(3) 2x8 #2 SYP	4	(2) 2x8 #2 SYP
5	(3) 2x10 #2 SYP	6	(2) 2x10 #2 SYP
7	(3) 2x12 #2 SYP	8	(2) 2x12 #2 SYP
9	NOT USED	10	NOT USED
11	(3) 1 3/4"x7 1/2" LVL's	12	(2) 1 3/4"x7 1/2" LVL's
13	(3) 1 3/4"x9 1/2" LVL's	14	(2) 1 3/4"x9 1/2" LVL's
15	(3) 1 3/4"x9 1/2" LVL's	16	(2) 1 3/4"x9 1/2" LVL's
17	(3) 1 3/4"x11 1/4" LVL's	18	(2) 1 3/4"x11 1/4" LVL's
19	(3) 1 3/4"x11 1/8" LVL's	20	(2) 1 3/4"x11 1/8" LVL's
21	(3) 1 3/4"x14" LVL's	22	(2) 1 3/4"x14" LVL's
23	(3) 1 3/4"x16" LVL's	24	(2) 1 3/4"x16" LVL's
25	(3) 1 3/4"x18" LVL's	26	(2) 1 3/4"x18" LVL's
27	(3) 1 3/4"x20" LVL's	28	(2) 1 3/4"x20" LVL's
29	(3) 2x8 #2 SYP PT	30	NOT USED
31	NOT USED	32	NOT USED

1. BEAMS ARE LABELED 'DROPPED', 'RAISED', OR 'FLUSH' TO INDICATE THE ELEVATION OF THE BEAM, AS DEFINED BELOW:


DROPPED: T/O BEAM = B/O TRUSS/JOIST  
RAISED: T/O BEAM = T/O TRUSS/JOIST  
FLUSH: B/O BEAM = B/O TRUSS/JOIST

2. SHIM BEAMS TO WALL WIDTH WHERE APPLICABLE.

3. 'PT' INDICATES PRESSURE TREATED LUMBER (ACQ).

DOORS AND WINDOWS:

1. DOORS AND HARDWARE SHALL COMPLY WITH IBC-2015, ANSI 117.1-2009, AND THE FAIR HOUSING ACT.
2. EQUIP ALL DOORS CONFORMING TO ANSI A156.2. INSTALL PER MANUFACTURER'S INSTRUCTIONS.
3. DOOR HARDWARE FINISH & STYLE TO BE SELECTED BY CONTRACTOR.
4. DOOR ASSEMBLIES IN CORRIDORS SHALL MEET THE FIRE RATINGS SHOWN IN THE DOOR SCHEDULE AND MEET THE REQUIREMENTS FOR SMOKE AND DRAFT CONTROL IN ACCORDANCE WITH UL 1784 (IBC 716.5.3.1).
5. ALL ROUGH OPENING DIMENSIONS FOR DOORS & WINDOWS MUST BE VERIFIED WITH GC PRIOR TO COMMENCING WORK.
6. ALL FIRE RATED DOORS AND SHUTTERS TO BE INSTALLED PER MANUFACTURER'S SPECIFICATIONS AND NFPA 80 (STANDARD FOR FIRE DOORS AND OTHER OPENING PROTECTIVES).

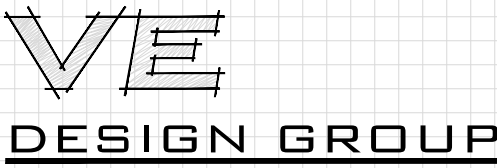


520 E JACKSON ST. SUITE 2  
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VE DESIGN GROUP OF MO, LLC  
MO CERTIFICATE OF AUTHORITY #201303374 (ENGINEERING)  
MO CERTIFICATE OF AUTHORITY #201304334 (ARCHITECTURE)

CHROMA II  
MIXED-USE DEVELOPMENT  
(CONCEPT 2.3)



NO	REVISIONS	DATE

DRAWING TITLE UNIT DOOR, WINDOW & MISC SCHEDULES	
PROJECT # 850	DRAWING NUMBER G5.1
DATE 02/22/19	DESIGN DEVELOPMENT

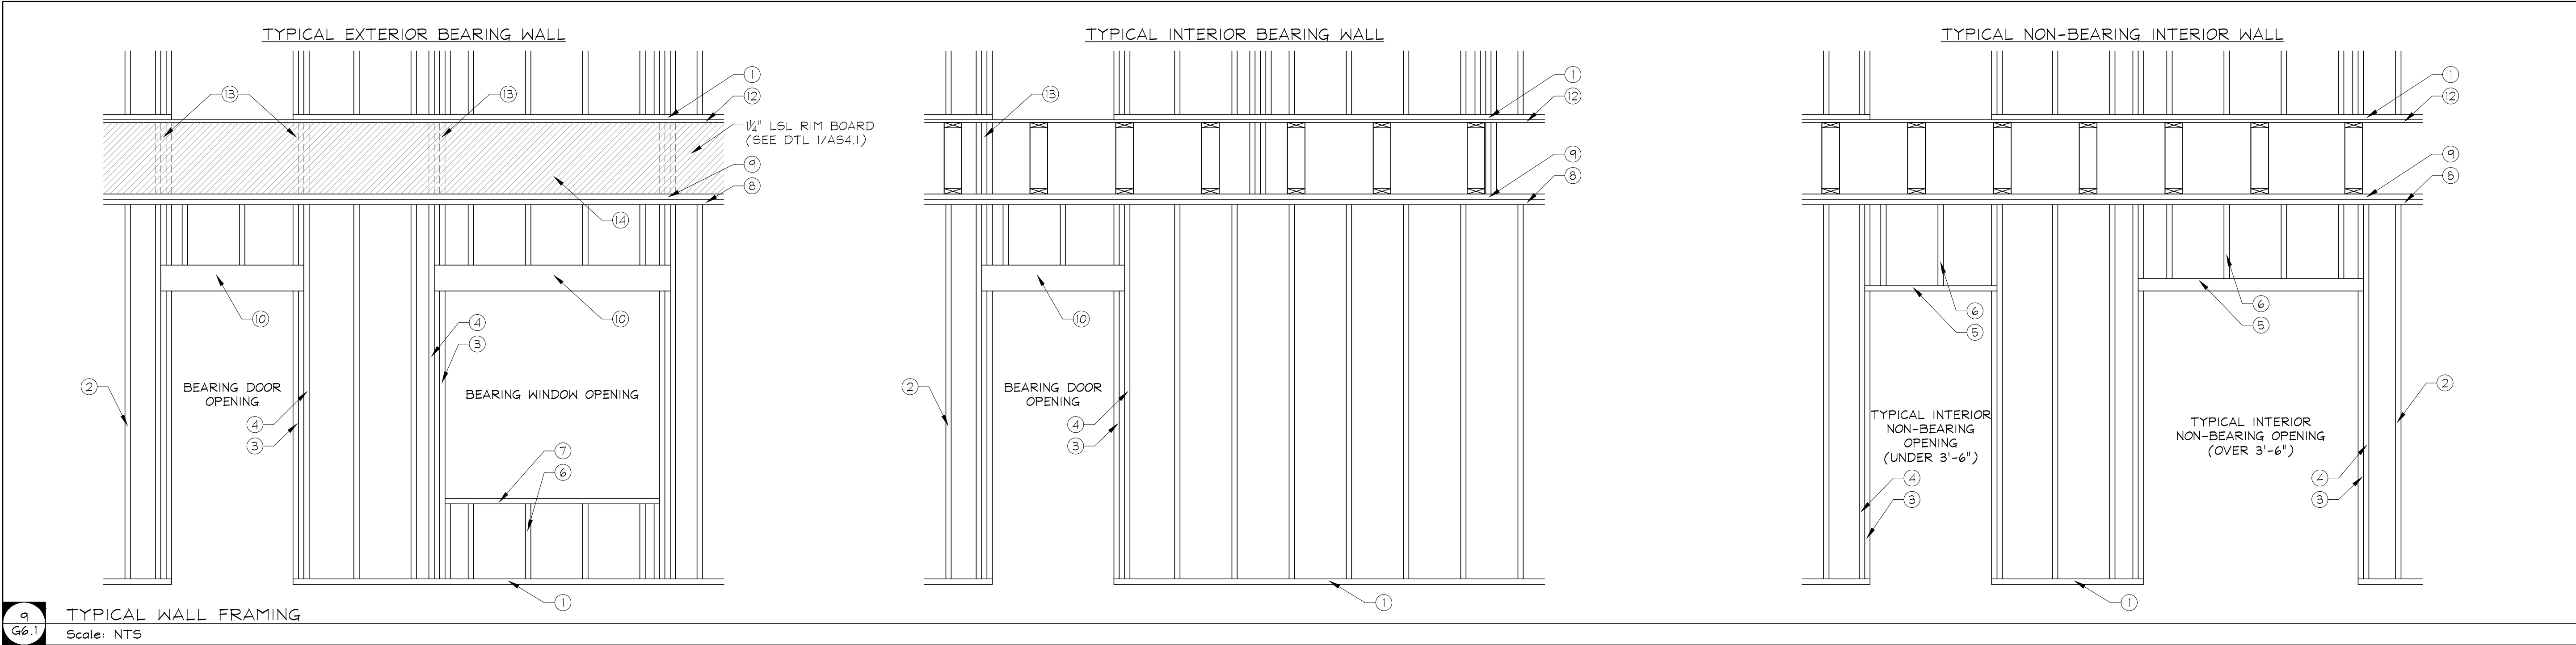

WALL COMPONENTS	
KEY	DESCRIPTION
1	BOTTOM PLATE
2	STUD
3	TRIMMER
4	KING STUD
5	HEADER CHORD
6	CRIPPLE STUD
7	SILL PLATE
8	TOP PLATE
9	2nd TOP PLATE
10	BEARING HEADER**
11	EXTERIOR SHEATHING
12	FLOOR SHEATHING
13	SQUASH BLOCKS
14	FLOOR RIM (SEE/AS4.1)

\*\* BEARING HEADERS SHALL BE SHIMMED TO FULL THICKNESS OF WALL WITH OSB/PLYWOOD

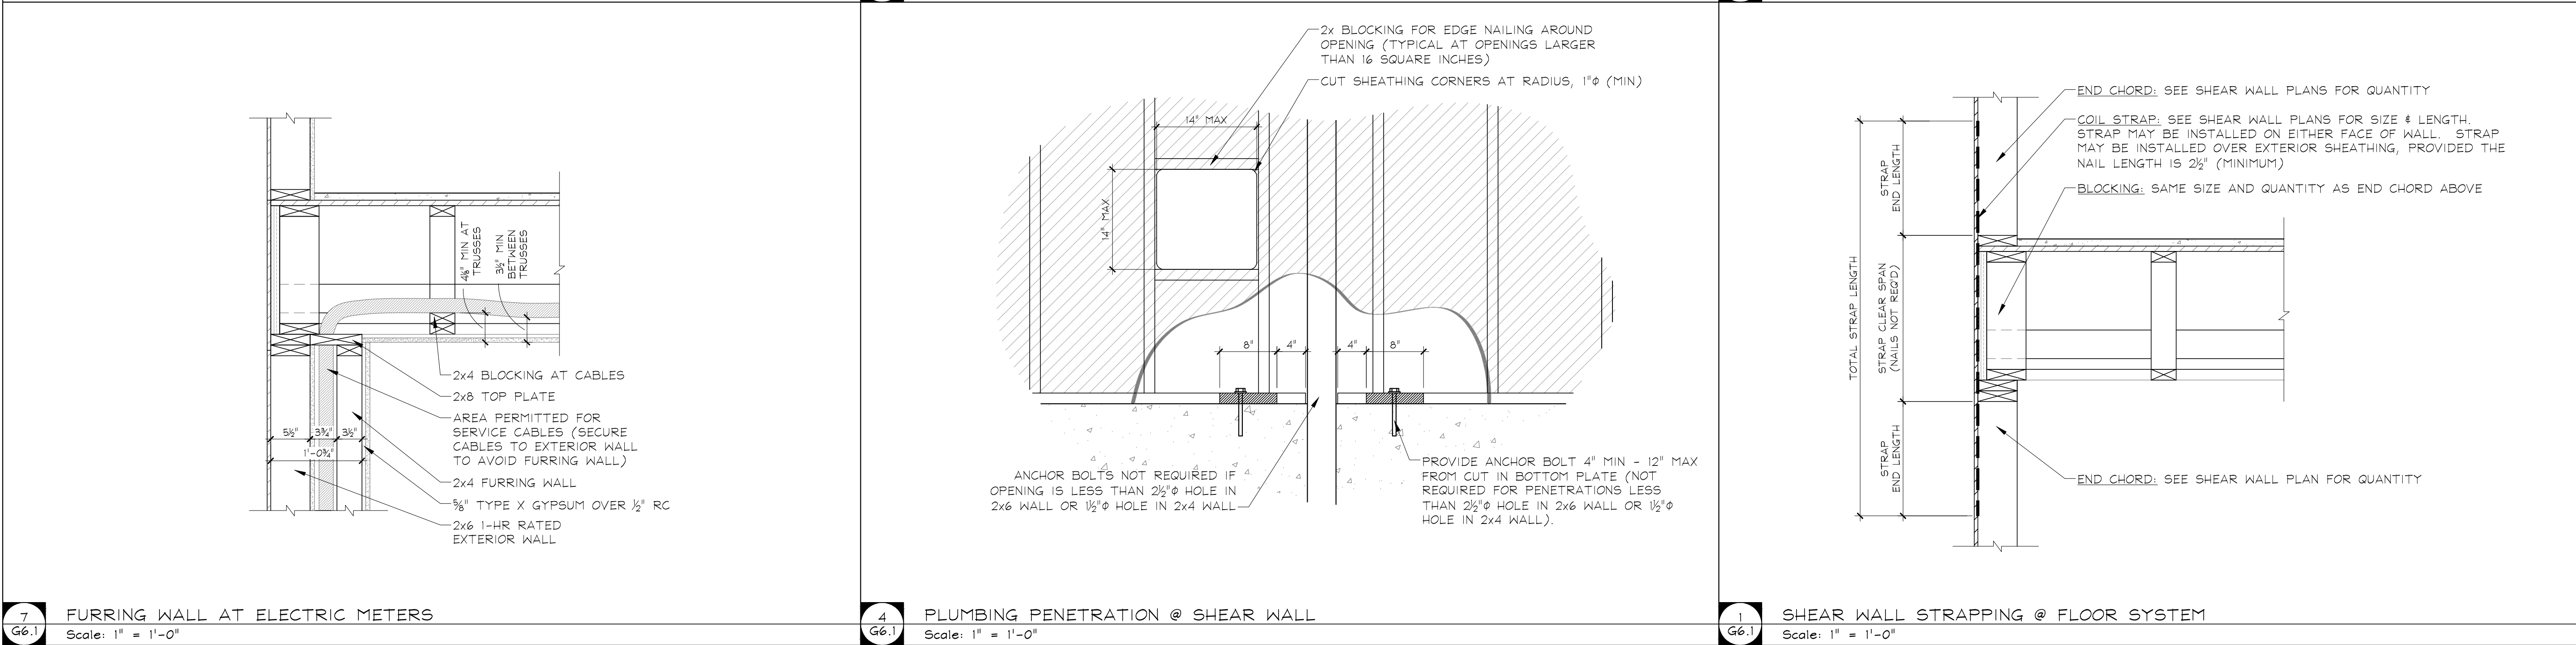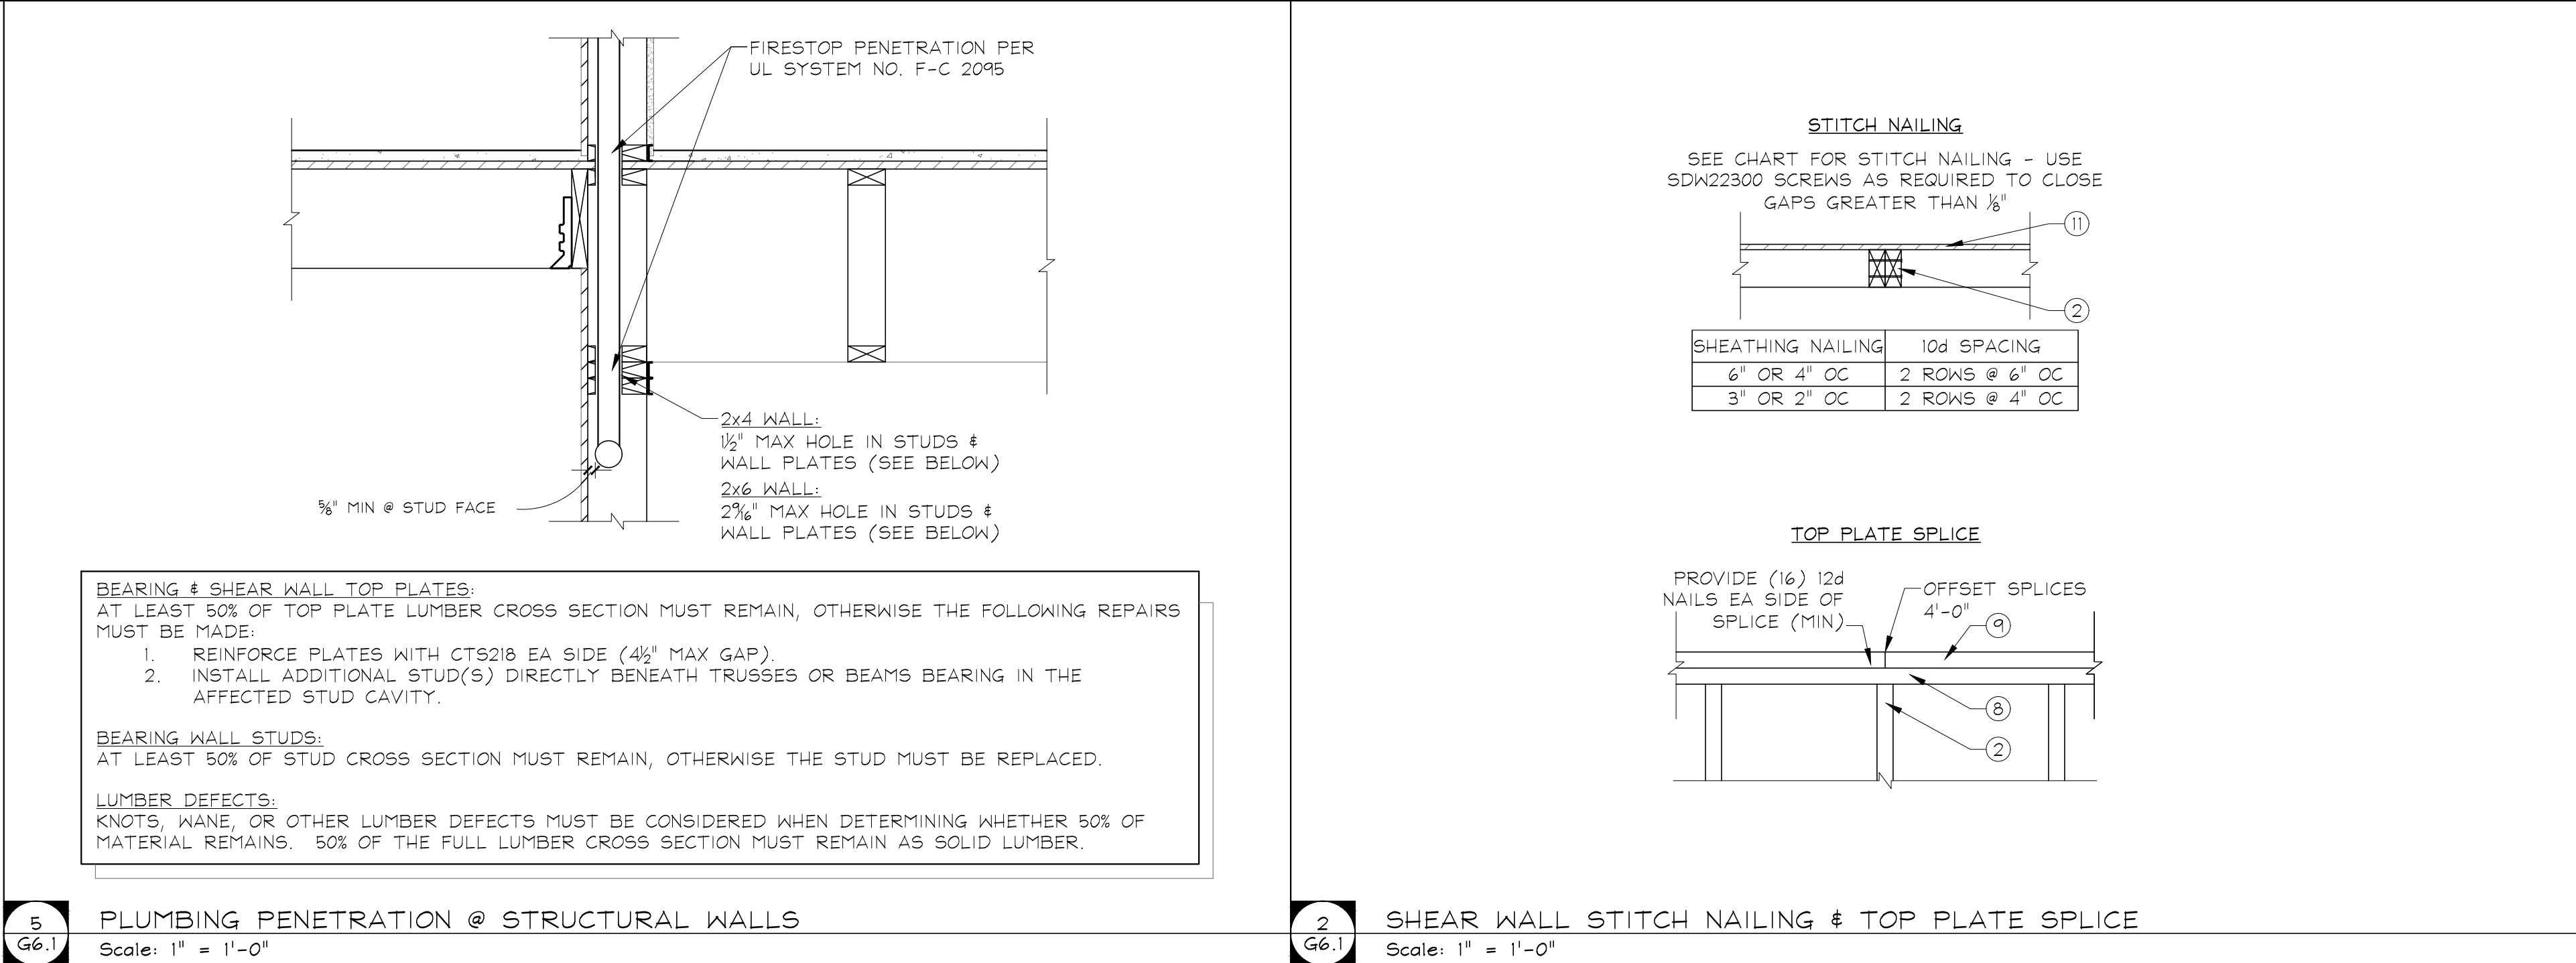


**VE DESIGN GROUP**

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DESIGN@VEDESIGNGROUP.COM


VE DESIGN GROUP OF MO, LLC  
MO CERTIFICATE OF AUTHORITY #2012033374 (ENGINEERING)  
MO CERTIFICATE OF AUTHORITY #2013004334 (ARCHITECTURE)

**CHROMA II  
MIXED-USE DEVELOPMENT  
(CONCEPT 2.3)**


ST. LOUIS, MO		
NO	REVISIONS	DATE
DRAWING TITLE		
TYPICAL FRAMING DETAILS		
PROJECT #	DRAWING NUMBER	
850	G6.1	
DATE	DESIGN DEVELOPMENT	
02/22/19		

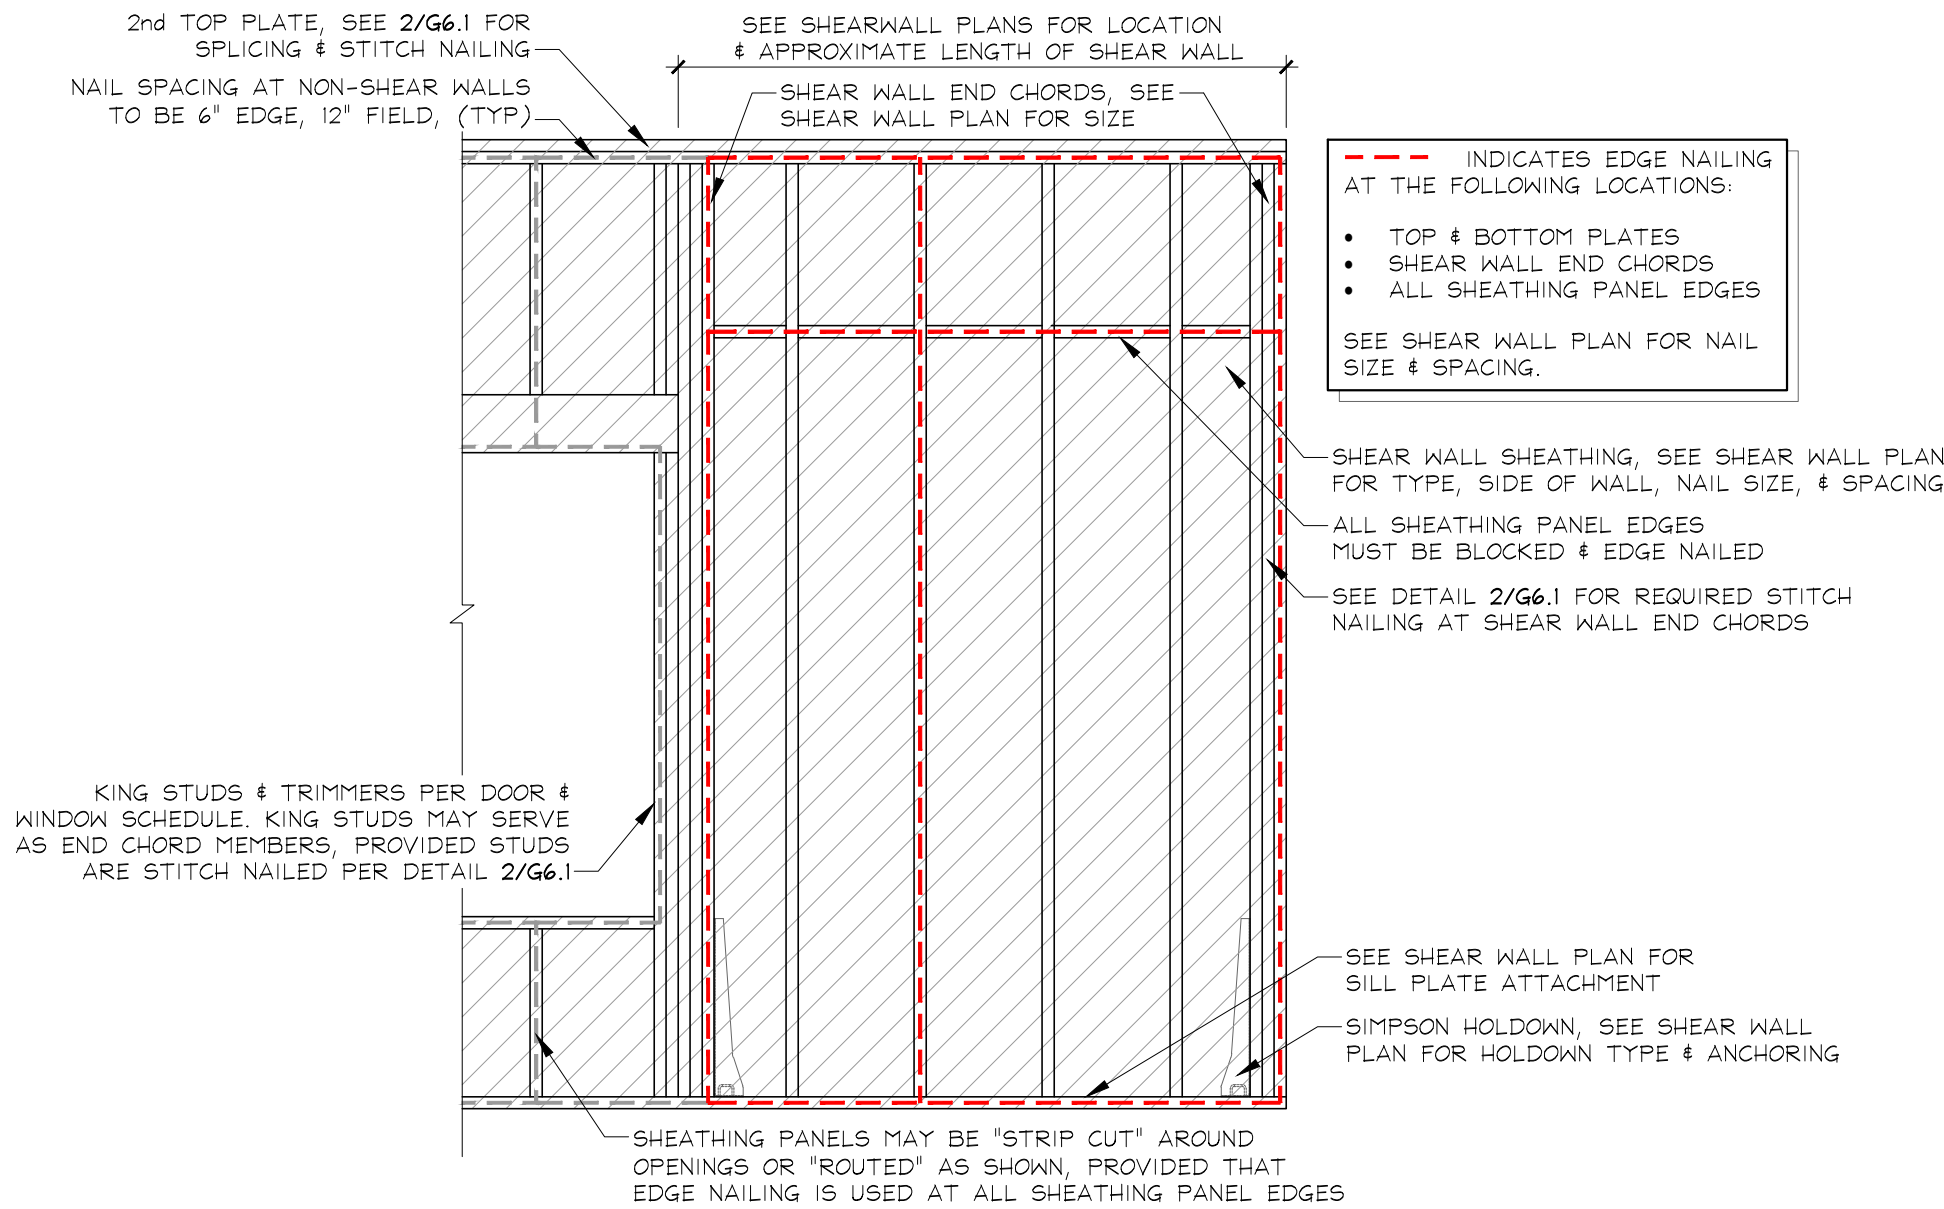

**2**  
**G6.2** SHEAR WALL ENDING AT OPENING (SEGMENTED)  
Scale: 1/2" = 1'-0"

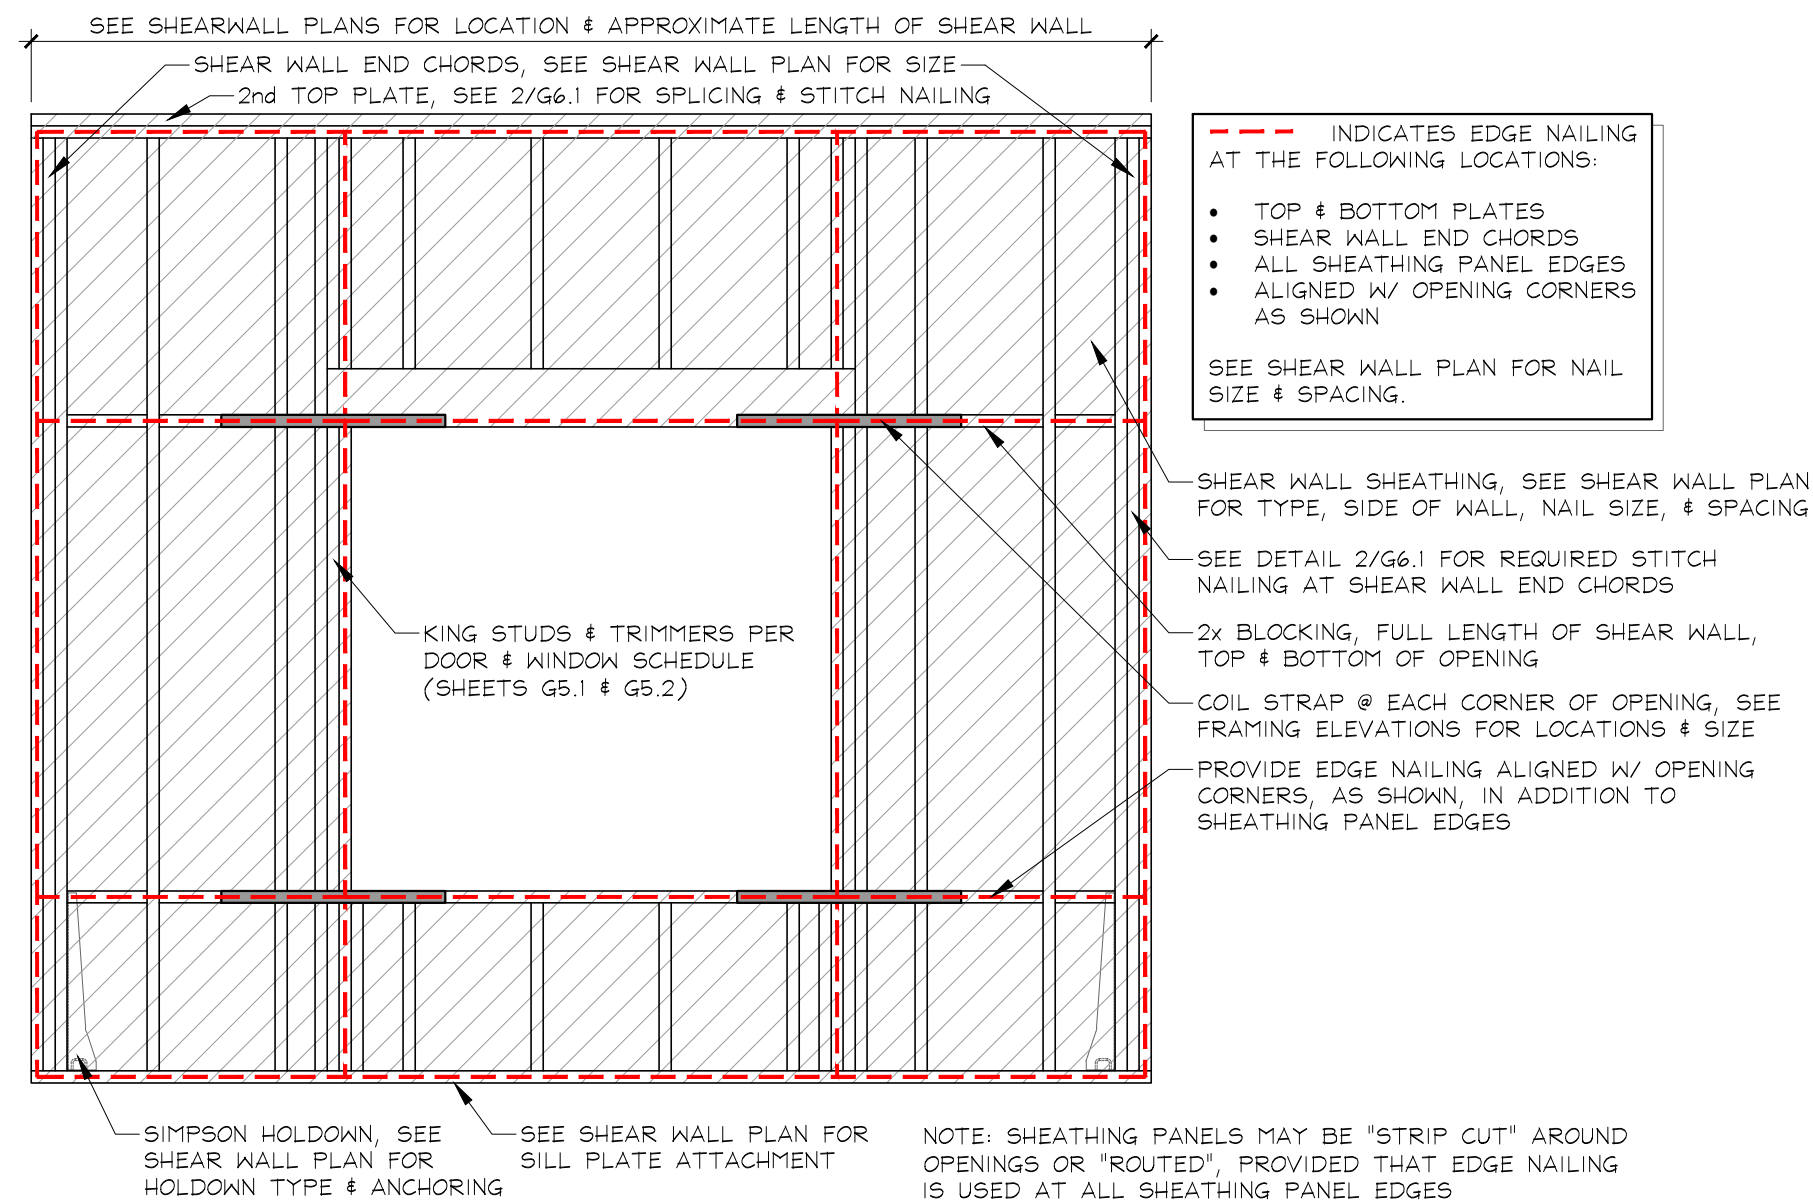

**3**  
**G6.2** SHEAR WALL ACROSS OPENING (FORCE TRANSFER AROUND OPENING)  
Scale: 1/2" = 1'-0"

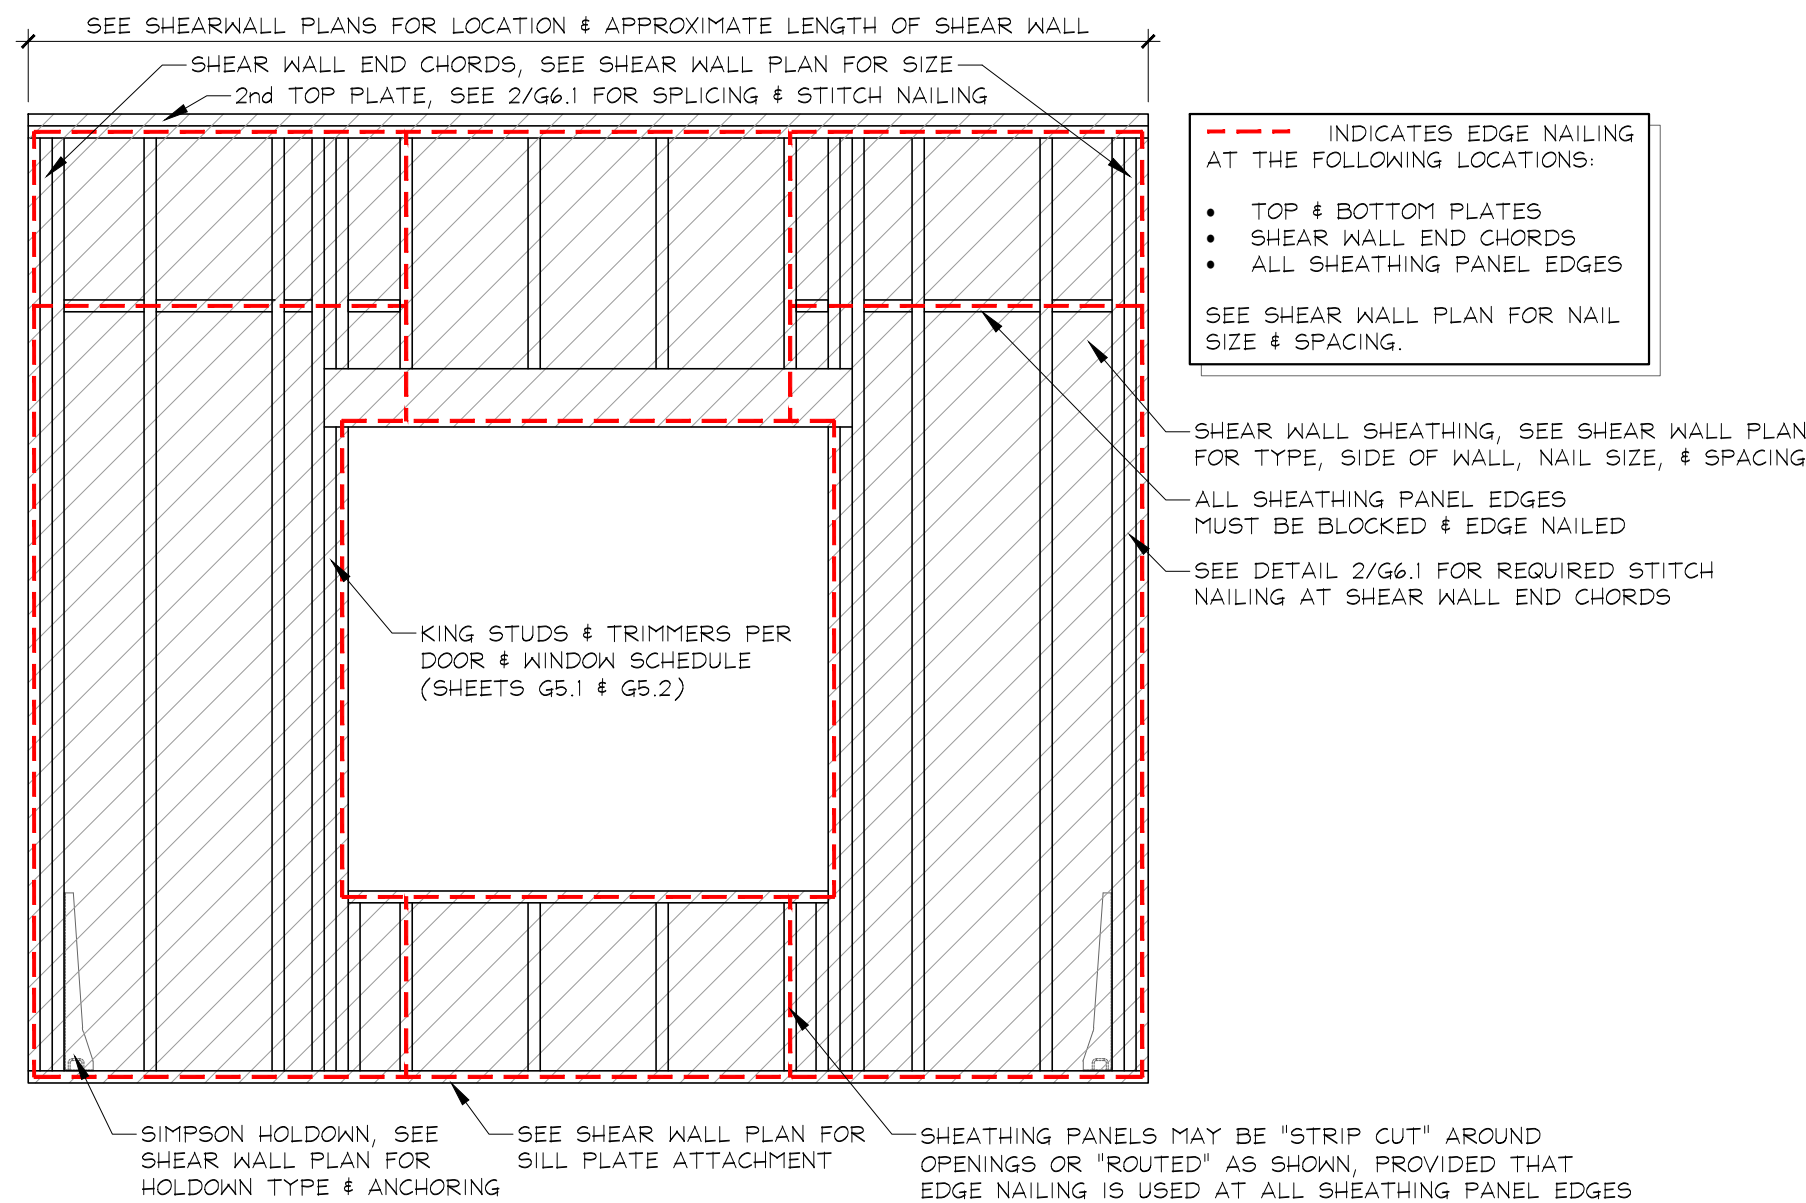

**1**  
**G6.2** SHEAR WALL ACROSS OPENING (PERFORATED)  
Scale: 1/2" = 1'-0"



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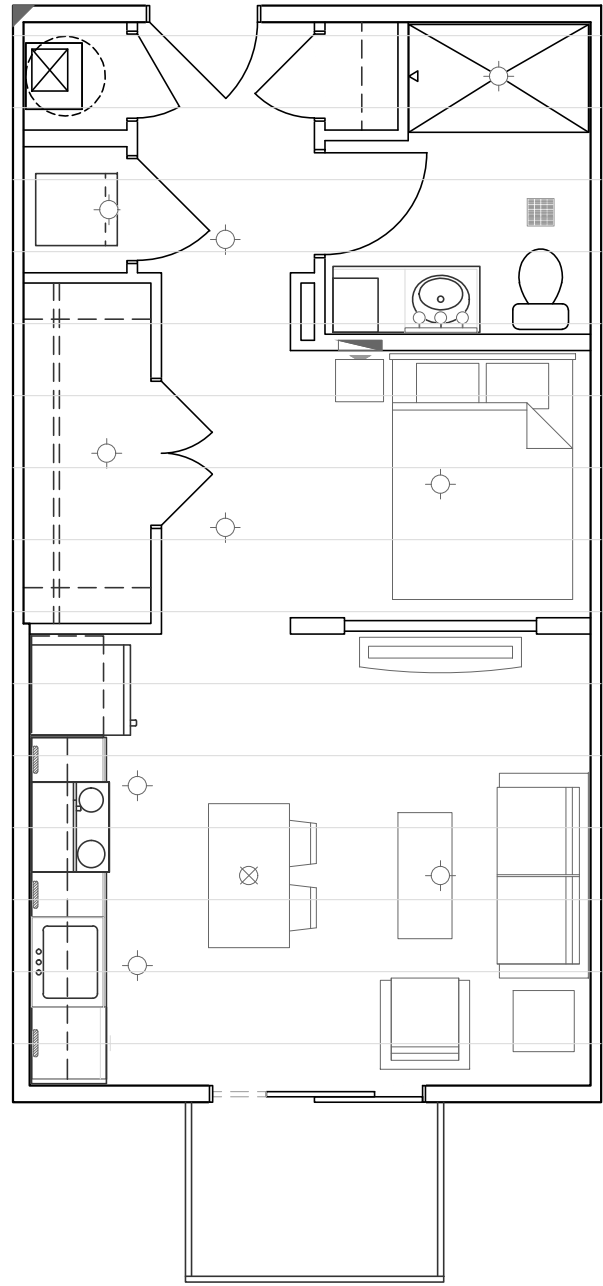
**CHROMA II  
MIXED-USE DEVELOPMENT  
(CONCEPT 2.3)**

ST. LOUIS, MO

NO	REVISIONS	DATE


DRAWING TITLE TYPICAL FRAMING DETAILS	
PROJECT # 850	DRAWING NUMBER G6.2
DATE 02/22/19	DESIGN DEVELOPMENT

- LIGHT FIXTURE PLACEMENT:**
- PLACE LIGHTS AS SHOWN. ADJUST FOR STRUCTURE AS NEEDED WHILE MAINTAINING DESIGN INTENT.
  - SEE INTERIOR ELEVATIONS (U4 SHEETS) FOR VANITY DIMENSIONS AND CENTER FIXTURES ACCORDINGLY.



UNIT S1 LIGHT FIXTURE & FURNITURE PLACEMENT PLAN  
Scale: 3/16" = 1'-0"

- == HIGH/LOW CLOSET RODS (T/SHELVES @ 42" / 84" AFF)
- SINGLE CLOSET ROD (T/SHELF @ 72" AFF). AT BEDROOM CLOSETS, INCLUDE ANGLED SHOE SHELF BELOW (14" AFF REAR, 7" AFF FRONT)
- \*\*\*\*\* INDICATES CROWN MOULDING
- ⎓ INDICATES ELECTRIC PANEL (SEE MEP)

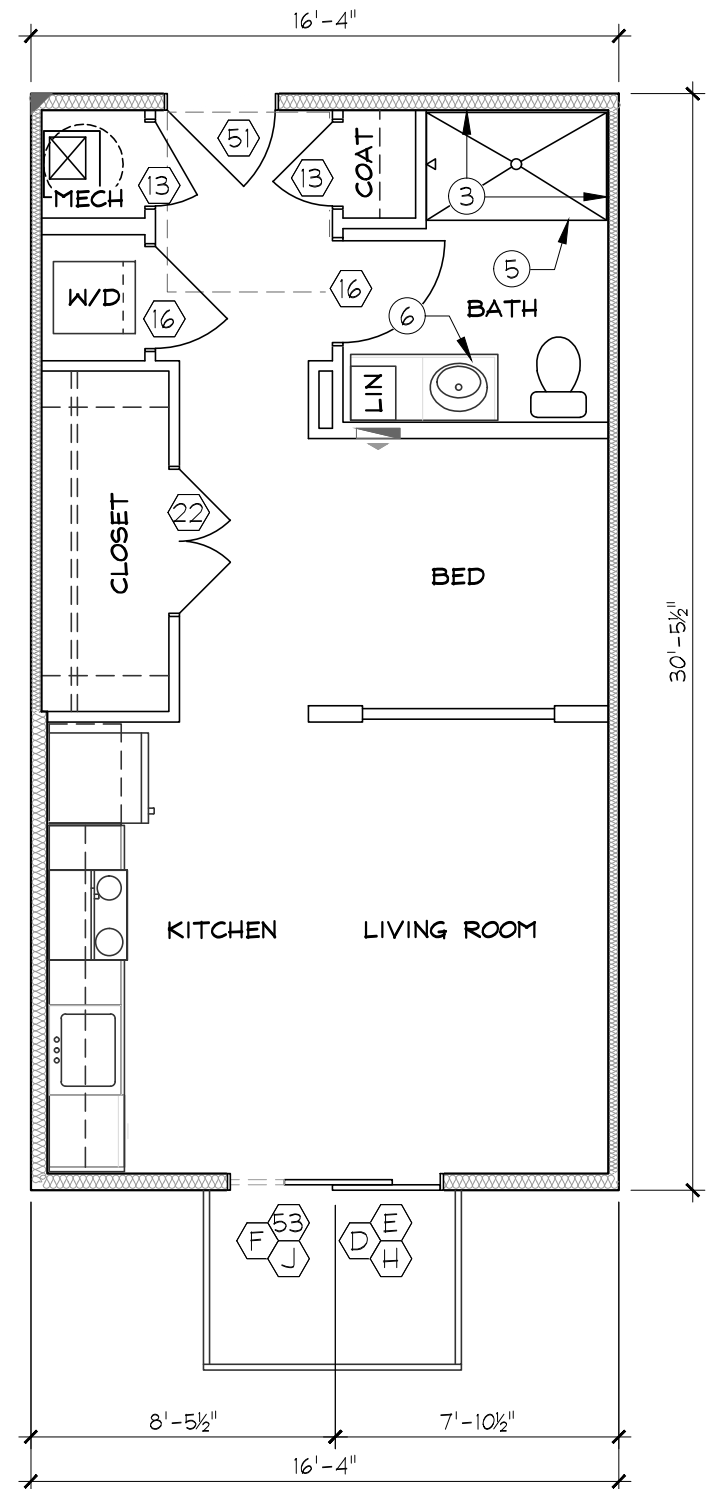

UNIT S1 FLOOR PLAN - HEATED SF (498) - QTY (12)  
Scale: 3/16" = 1'-0"

- (#) INDICATES DOOR OR WINDOW TYPE. SEE G5.1 & G5.2 FOR SCHEDULE. WHERE MULTIPLE TYPES ARE SHOWN, SEE FRAMING ELEVATIONS.
- ||||| INDICATES R13 BATTS @ 2x4 INTERIOR WALLS, R19 BATTS @ 2x6 EXTERIOR WALLS AND CORRIDOR WALLS.

- UNIT PLAN NOTES:
1. ALL DIMENSIONS ARE TO FACE OF STUD OR CENTERLINE OF TRUSS (UNO).
  2. DOORS & WINDOWS ARE DIMENSIONED TO CENTER, CENTERED BETWEEN ADJACENT WALLS OR 3" AWAY FROM NEAREST WALL.
  3. SEE BUILDING FLOOR PLANS FOR OVERALL BUILDING LAYOUT AND SPECIFICATIONS.
  4. ⬛ INDICATES REFERENCE POINT FOR STARTING DIMENSIONAL LAYOUT & UNIT ORIENTATION.
  5. ALL UNITS ARE 'TYPE B' (UNO). SEE BUILDING PLANS FOR UNITS COMPLYING WITH 'TYPE A' AND 'IAC' REQUIREMENTS. SEE G4.1- G4.2 FOR REQUIRED CLEARANCES AT FIXTURES, APPLIANCES, KITCHEN ISLANDS, ETC.
  6. UNIT FINISHES TO BE SELECTED BY OWNER.
  7. SEE U4.1-U4.4 FOR INTERIOR ELEVATIONS AT KITCHENS AND BATHS.
  8. SEE G0.1 FOR GENERAL NOTES.
  9. FLOOR ASSEMBLIES & FINISHES:
    - 9.1. ▨ INDICATES CARPET & PADDING OVER 1" GYP-CRETE OVER 3/4" SUBFLOOR OVER OPEN-WEB FLOOR TRUSSES WITH INSULATION, RESILIENT CHANNEL AND 5/8" GYPSUM CEILING (UNO). (UL #L521, STC 56, IIC 69).
    - 9.2. ▨ INDICATES VINYL PLANK OVER 3/4" GYP-CRETE OVER 1/2" SOUND MAT OVER 1/2" SUBFLOOR OVER OPEN-WEB FLOOR TRUSSES WITH INSULATION, RESILIENT CHANNEL AND 5/8" GYPSUM CEILING. (UL #L521, STC 56, IIC 56).
    - 9.3. ▨ INDICATES CERAMIC TILE OVER 3/4" GYP-CRETE OVER 1/2" SOUND MAT OVER 1/2" SUBFLOOR OVER OPEN-WEB FLOOR TRUSSES WITH INSULATION, RESILIENT CHANNEL AND 5/8" GYPSUM CEILING. (UL #L521, STC 56, IIC 54).

- KEY NOTES:
- ① 18" DEEP OPEN WEB, METAL PLATE CONNECTED WOOD FLOOR TRUSSES SPACED @ 24" OC (UNO)
  - ② 2x6 KNEE WALL
  - ③ REQUIRES PRE-INSTALLED 5/8" TYPE 'X' GYP AT WALL AND/OR CEILING PRIOR TO COMPLETION OF FRAMING OR INSTALL OF FIXTURE TO MAINTAIN FIRE-RATING
  - ④ 36" x 60" TUB w/ SURROUND (UNO)
  - ⑤ 36" x 60" SHOWER BASE w/ SURROUND (UNO)
  - ⑥ VANITY CABINET & COUNTERTOP (SEE U4.4)
  - ⑦ 42" GUARD RAIL w/ BALUSTERS @ 4" OC (MAX) (SEE BLDG FLOOR PLANS & ELEVATIONS FOR UNITS W/OUT RAILING)
  - ⑧ 2x10's #2 SYP PT @ 16" OC

- UNIT FLOOR FRAMING NOTES:**
- PLAN SHOWS UNIT FLOOR SYSTEM AND WALLS BELOW.
  - VERIFY PLUMBING DRAIN LOCATIONS WITH CONTRACTOR AND ADJUST TRUSS SPACING AS REQUIRED.
  - SEE BUILDING FRAMING PLANS FOR CORRIDOR FRAMING & ADDITIONAL FRAMING DETAIL CALLOUTS.


- INDICATES WALL DESIGNATED FOR PLUMBING PENETRATIONS.
- INDICATES PLUMBING VENT (2" MAX I.D.), OFFSET FROM LIGHT FIXTURE 6" MINIMUM.
- ▨ INDICATES INTERIOR LOAD BEARING WALL (LEVELS 1-3). ALL UNIT PERIMETER WALLS ARE BEARING (UNO).
- ◊ INDICATES BEAM FOR TRUSS BEARING. SEE G5.1 FOR BEAM SCHEDULE.



UNIT S1 FLOOR FRAMING  
Scale: 3/16" = 1'-0"

- UNIT WALL FRAMING NOTES:**
- UNSHADED WALLS ARE NON-BEARING (SPF STUD GRADE @ 16 OC).
  - INTERIOR NON-BEARING WALLS ARE 2x4 (UNO).
  - SEE FLOOR AND ROOF FRAMING PLANS FOR BEAM INFORMATION.
  - SEE SHEAR WALL PLANS FOR EXTERIOR SHEATHING TYPE & FASTENING.

- 3 FLOOR(S) ABOVE  
2 FLOOR(S) ABOVE  
1 FLOOR(S) ABOVE  
0 FLOOR(S) ABOVE
- 615 A A A A INDICATES BEARING WALL STUD SPECIFICATIONS. SEE G5.1 FOR SCHEDULE. COLOR SHOWN IN WALL INDICATES SPECS FOR THE LOWEST LEVEL ON WHICH THE UNIT OCCURS.
- INDICATES UNIT TYPE DOES NOT OCCUR AT LEVEL SHOWN.
- ▨ INDICATES WALL IS NON-BEARING AT LEVEL SHOWN.

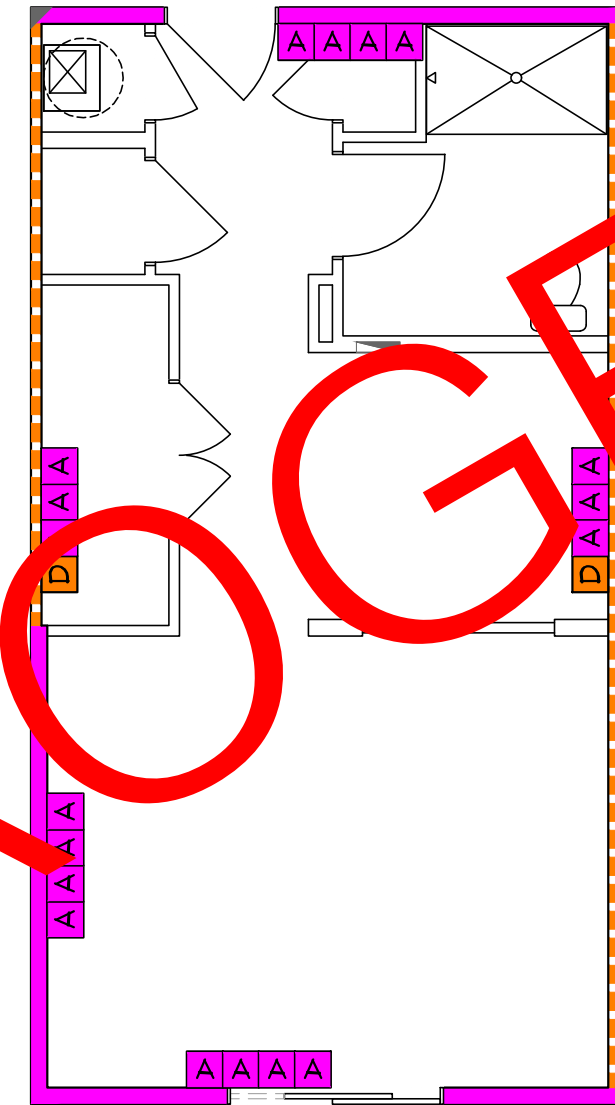

COMPLETE WALL FRAMING  
DIMENSIONS TO BE PROVIDED IN  
CONSTRUCTION RELEASE PLANS

UNIT S1 WALL FRAMING  
Scale: 3/16" = 1'-0"

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**CHROMA II**  
**MIXED-USE DEVELOPMENT**  
(CONCEPT 2.3)


ST. LOUIS, MO

NO	REVISIONS	DATE

DRAWING TITLE  
UNIT PLANS: S1


PROJECT #	DRAWING NUMBER
850	U1.1
DATE	DESIGN DEVELOPMENT
02/22/19	

- LIGHT FIXTURE PLACEMENT:**
- PLACE LIGHTS AS SHOWN. ADJUST FOR STRUCTURE AS NEEDED WHILE MAINTAINING DESIGN INTENT.
  - SEE INTERIOR ELEVATIONS (U4 SHEETS) FOR VANITY DIMENSIONS AND CENTER FIXTURES ACCORDINGLY.

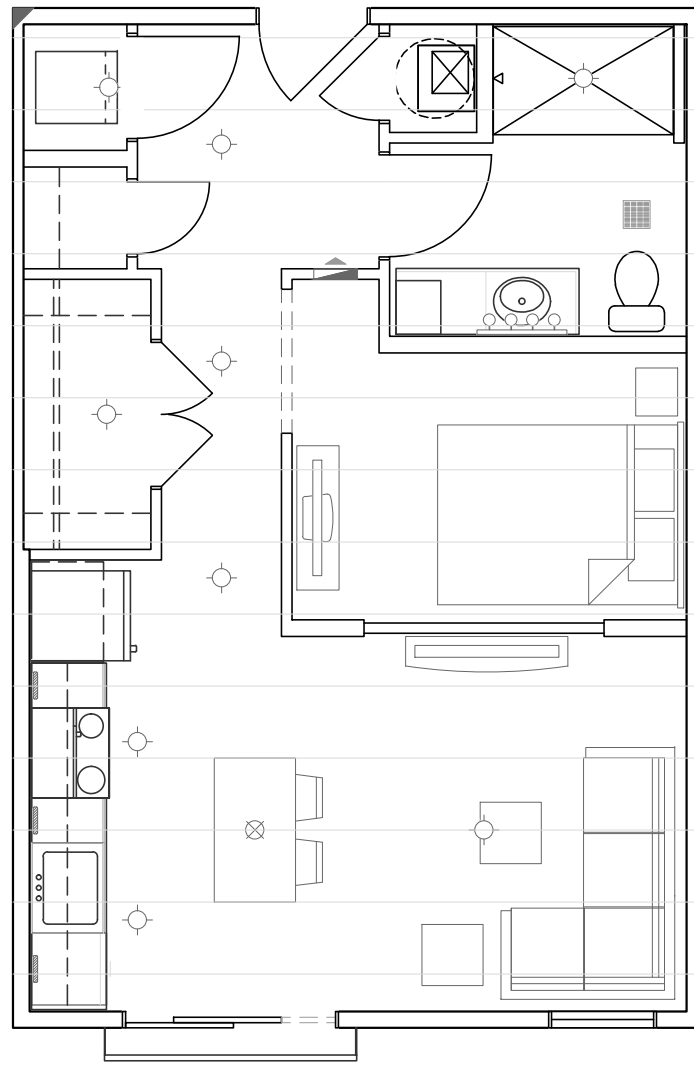

UNIT S2 LIGHT FIXTURE & FURNITURE PLACEMENT PLAN  
Scale: 3/16" = 1'-0"

- == HIGH/LOW CLOSET RODS (T/SHELVES @ 42" / 84" AFF)
- SINGLE CLOSET ROD (T/SHELF @ 72" AFF). AT BEDROOM CLOSETS, INCLUDE ANGLED SHOE SHELF BELOW (14" AFF REAR, 7" AFF FRONT)
- \*\*\*\*\* INDICATES CROWN MOULDING
- ⚡ INDICATES ELECTRIC PANEL (SEE MEP)

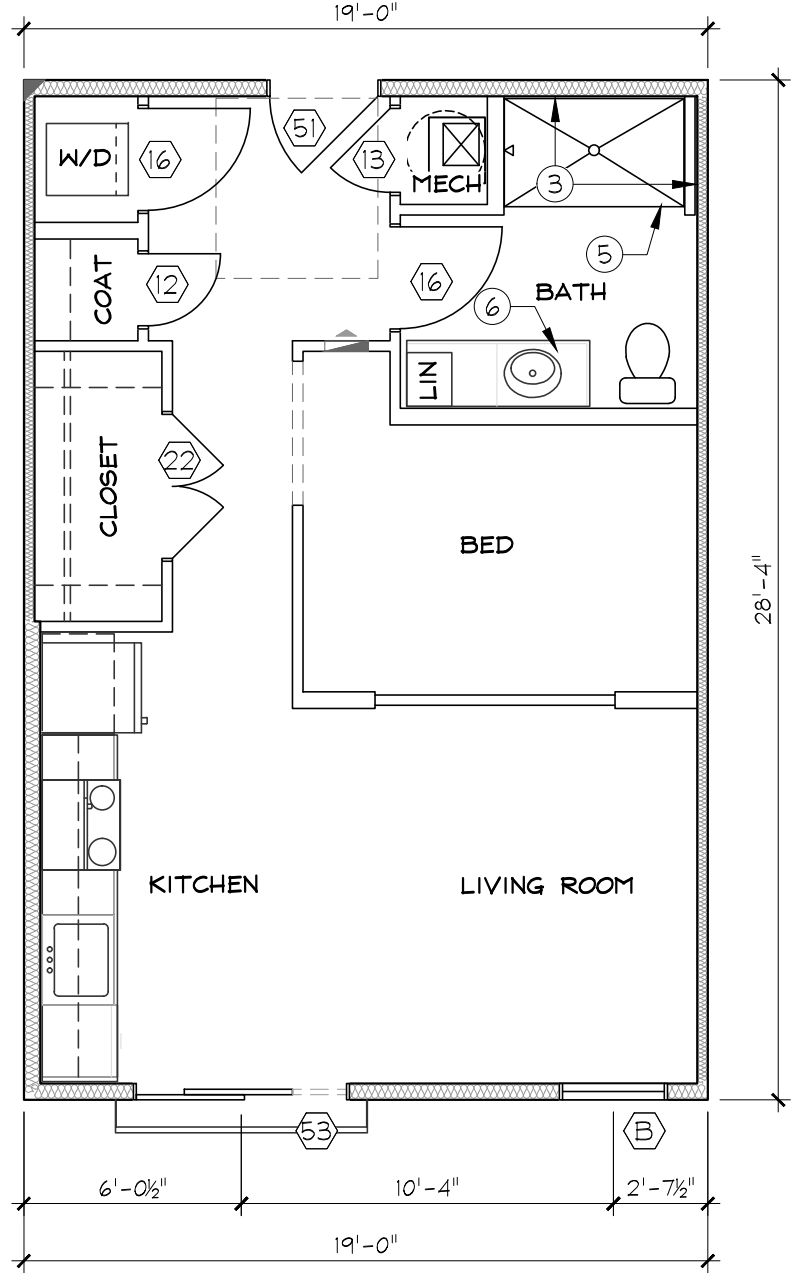


UNIT S2 FLOOR PLAN - HEATED SF (538) - QTY (3)  
Scale: 3/16" = 1'-0"

- (#) INDICATES DOOR OR WINDOW TYPE. SEE G5.1 & G5.2 FOR SCHEDULE. WHERE MULTIPLE TYPES ARE SHOWN, SEE FRAMING ELEVATIONS.
- ||||| INDICATES R13 BATTS @ 2x4 INTERIOR WALLS, R19 BATTS @ 2x6 EXTERIOR WALLS AND CORRIDOR WALLS.

- UNIT PLAN NOTES:
1. ALL DIMENSIONS ARE TO FACE OF STUD OR CENTERLINE OF TRUSS (UNO).
  2. DOORS & WINDOWS ARE DIMENSIONED TO CENTER, CENTERED BETWEEN ADJACENT WALLS OR 3" AWAY FROM NEAREST WALL.
  3. SEE BUILDING FLOOR PLANS FOR OVERALL BUILDING LAYOUT AND SPECIFICATIONS.
  4. ▀ INDICATES REFERENCE POINT FOR STARTING DIMENSIONAL LAYOUT & UNIT ORIENTATION.
  5. ALL UNITS ARE 'TYPE B' (UNO). SEE BUILDING PLANS FOR UNITS COMPLYING WITH TYPE 'A' AND 'IAC' REQUIREMENTS. SEE G4.1- G4.2 FOR REQUIRED CLEARANCES AT FIXTURES, APPLIANCES, KITCHEN ISLANDS, ETC.
  6. UNIT FINISHES TO BE SELECTED BY OWNER.
  7. SEE U4.1-U4.4 FOR INTERIOR ELEVATIONS AT KITCHENS AND BATHS.
  8. SEE G0.1 FOR GENERAL NOTES.
  9. FLOOR ASSEMBLIES & FINISHES:
    - 9.1. ▨ INDICATES CARPET & PADDING OVER 1" GYP-CRETE OVER 3/4" SUBFLOOR OVER OPEN-WEB FLOOR TRUSSES WITH INSULATION, RESILIENT CHANNEL AND 5/8" GYPSUM CEILING (UNO). (UL #L521, STC 56, IIC 69).
    - 9.2. ▨ INDICATES VINYL PLANK OVER 3/4" GYP-CRETE OVER 1/2" SOUND MAT OVER 1/2" SUBFLOOR OVER OPEN-WEB FLOOR TRUSSES WITH INSULATION, RESILIENT CHANNEL AND 5/8" GYPSUM CEILING. (UL #L521, STC 56, IIC 56).
    - 9.3. ▨ INDICATES CERAMIC TILE OVER 3/4" GYP-CRETE OVER 1/2" SOUND MAT OVER 1/2" SUBFLOOR OVER OPEN-WEB FLOOR TRUSSES WITH INSULATION, RESILIENT CHANNEL AND 5/8" GYPSUM CEILING. (UL #L521, STC 56, IIC 54).

- KEY NOTES:
- ① 18" DEEP OPEN WEB, METAL PLATE CONNECTED WOOD FLOOR TRUSSES SPACED @ 24" OC (UNO)
  - ② 2x6 KNEE WALL
  - ③ REQUIRES PRE-INSTALLED 5/8" TYPE 'X' GYP AT WALL AND/OR CEILING PRIOR TO COMPLETION OF FRAMING OR INSTALL OF FIXTURE TO MAINTAIN FIRE-RATING
  - ④ 36" x 60" TUB w/ SURROUND (UNO)
  - ⑤ 36" x 60" SHOWER BASE w/ SURROUND (UNO)
  - ⑥ VANITY CABINET & COUNTERTOP (SEE U4.4)
  - ⑦ 42" GUARD RAIL w/ BALUSTERS @ 4" OC (MAX) (SEE BLDG FLOOR PLANS & ELEVATIONS FOR UNITS W/OUT RAILING)
  - ⑧ 2x10's #2 SYP PT @ 16" OC

- UNIT FLOOR FRAMING NOTES:**
- PLAN SHOWS UNIT FLOOR SYSTEM AND WALLS BELOW.
  - VERIFY PLUMBING DRAIN LOCATIONS WITH CONTRACTOR AND ADJUST TRUSS SPACING AS REQUIRED.
  - SEE BUILDING FRAMING PLANS FOR CORRIDOR FRAMING & ADDITIONAL FRAMING DETAIL CALLOUTS.

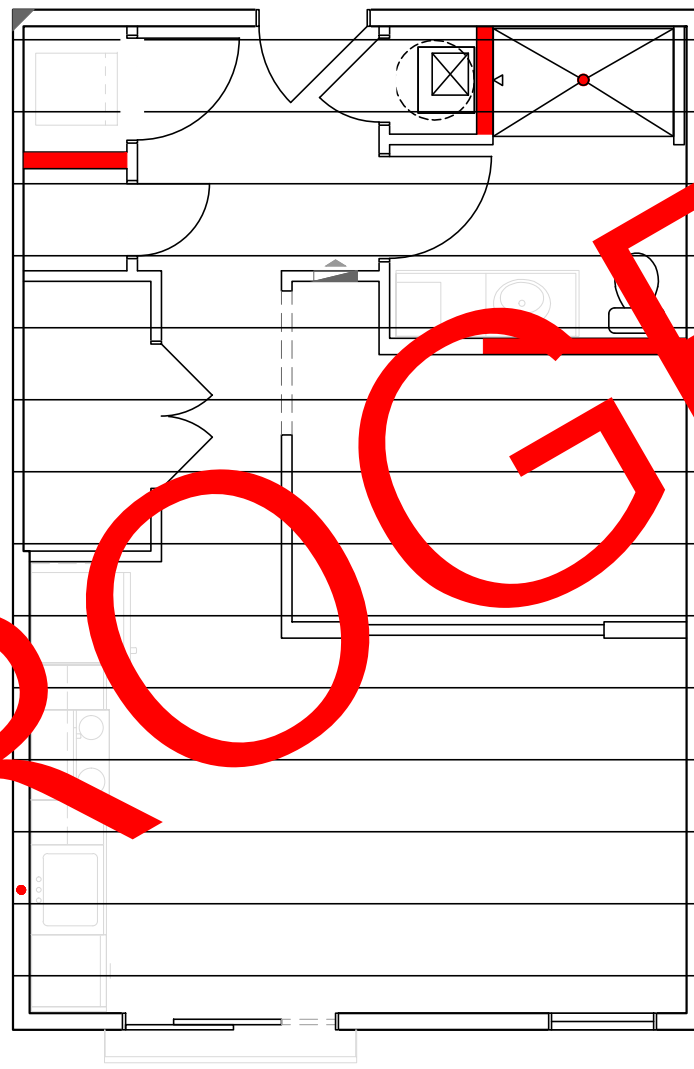


UNIT S2 FLOOR FRAMING  
Scale: 3/16" = 1'-0"

- INDICATES WALL DESIGNATED FOR PLUMBING PENETRATIONS.
- INDICATES PLUMBING VENT (2" MAX I.D.), OFFSET FROM LIGHT FIXTURE 6" MINIMUM.
- ▨ INDICATES INTERIOR LOAD BEARING WALL (LEVELS 1-3). ALL UNIT PERIMETER WALLS ARE BEARING (UNO).
- ◊ INDICATES BEAM FOR TRUSS BEARING. SEE G5.1 FOR BEAM SCHEDULE.

- UNIT WALL FRAMING NOTES:**
- UNSHADED WALLS ARE NON-BEARING (SPF STUD GRADE @ 16 OC).
  - INTERIOR NON-BEARING WALLS ARE 2x4 (UNO).
  - SEE FLOOR AND ROOF FRAMING PLANS FOR BEAM INFORMATION.
  - SEE SHEAR WALL PLANS FOR EXTERIOR SHEATHING TYPE & FASTENING.

- 3 FLOOR(S) ABOVE  
2 FLOOR(S) ABOVE  
1 FLOOR(S) ABOVE  
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- 615 A A A A INDICATES BEARING WALL STUD SPECIFICATIONS. SEE G5.1 FOR SCHEDULE. COLOR SHOWN IN WALL INDICATES SPECS FOR THE LOWEST LEVEL ON WHICH THE UNIT OCCURS.
- INDICATES UNIT TYPE DOES NOT OCCUR AT LEVEL SHOWN.
- ▨ INDICATES WALL IS NON-BEARING AT LEVEL SHOWN.

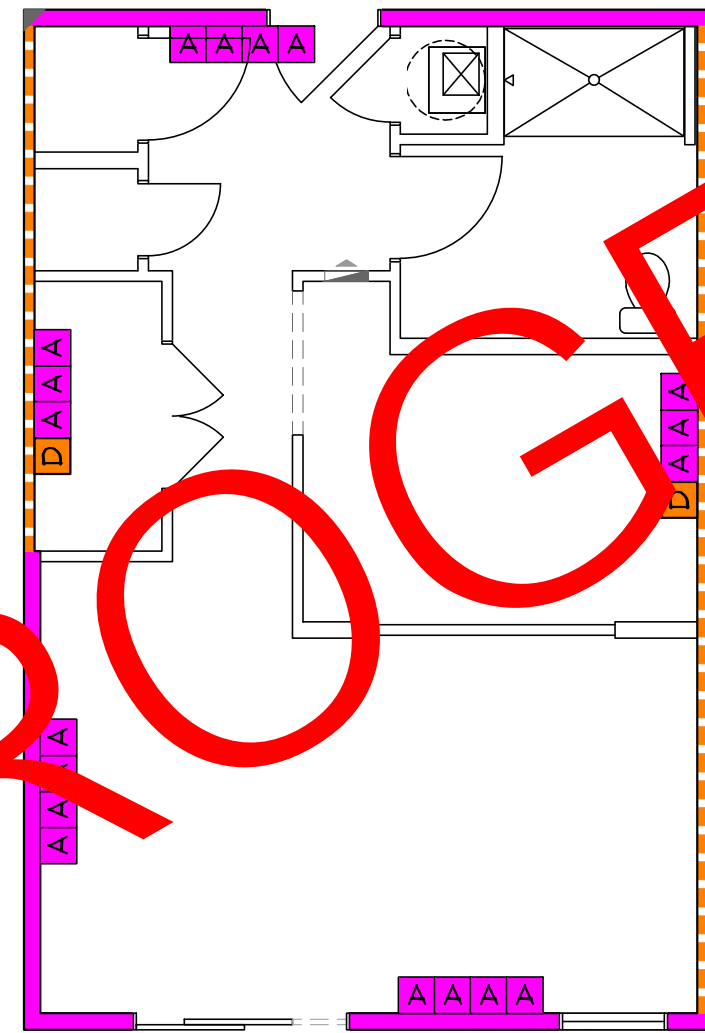

UNIT S2 WALL FRAMING  
Scale: 3/16" = 1'-0"

COMPLETE WALL FRAMING  
DIMENSIONS TO BE PROVIDED IN  
CONSTRUCTION RELEASE PLANS

**VE**  
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**CHROMA II**  
**MIXED-USE DEVELOPMENT**  
(CONCEPT 2.3)


ST. LOUIS, MO

NO	REVISIONS	DATE

DRAWING TITLE  
UNIT PLANS: S2

PROJECT #	DRAWING NUMBER
850	U1.2
DATE	DESIGN DEVELOPMENT
02/22/19	


- LIGHT FIXTURE PLACEMENT:**
- PLACE LIGHTS AS SHOWN. ADJUST FOR STRUCTURE AS NEEDED WHILE MAINTAINING DESIGN INTENT.
  - SEE INTERIOR ELEVATIONS (U4 SHEETS) FOR VANITY DIMENSIONS AND CENTER FIXTURES ACCORDINGLY.

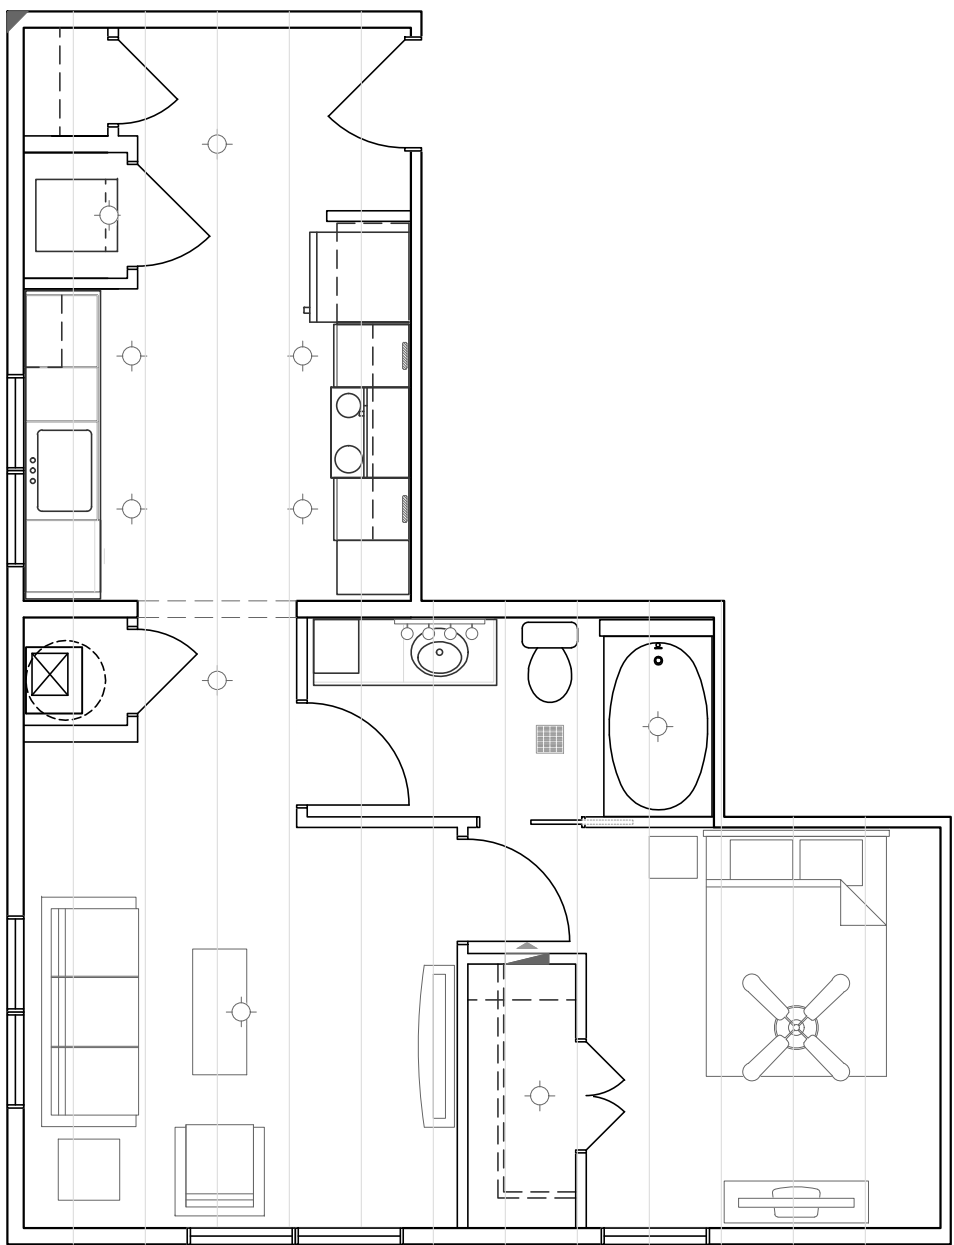

UNIT A1 LIGHT FIXTURE & FURNITURE PLACEMENT PLAN  
Scale: 3/16" = 1'-0"


- UNIT FLOOR FRAMING NOTES:**
- PLAN SHOWS UNIT FLOOR SYSTEM AND WALLS BELOW.
  - VERIFY PLUMBING DRAIN LOCATIONS WITH CONTRACTOR AND ADJUST TRUSS SPACING AS REQUIRED.
  - SEE BUILDING FRAMING PLANS FOR CORRIDOR FRAMING & ADDITIONAL FRAMING DETAIL CALLOUTS.

- INDICATES WALL DESIGNATED FOR PLUMBING PENETRATIONS.
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- ▨ INDICATES INTERIOR LOAD BEARING WALL (LEVELS 1-3). ALL UNIT PERIMETER WALLS ARE BEARING (UNO).
- ◊ INDICATES BEAM FOR TRUSS BEARING. SEE G5.1 FOR BEAM SCHEDULE.

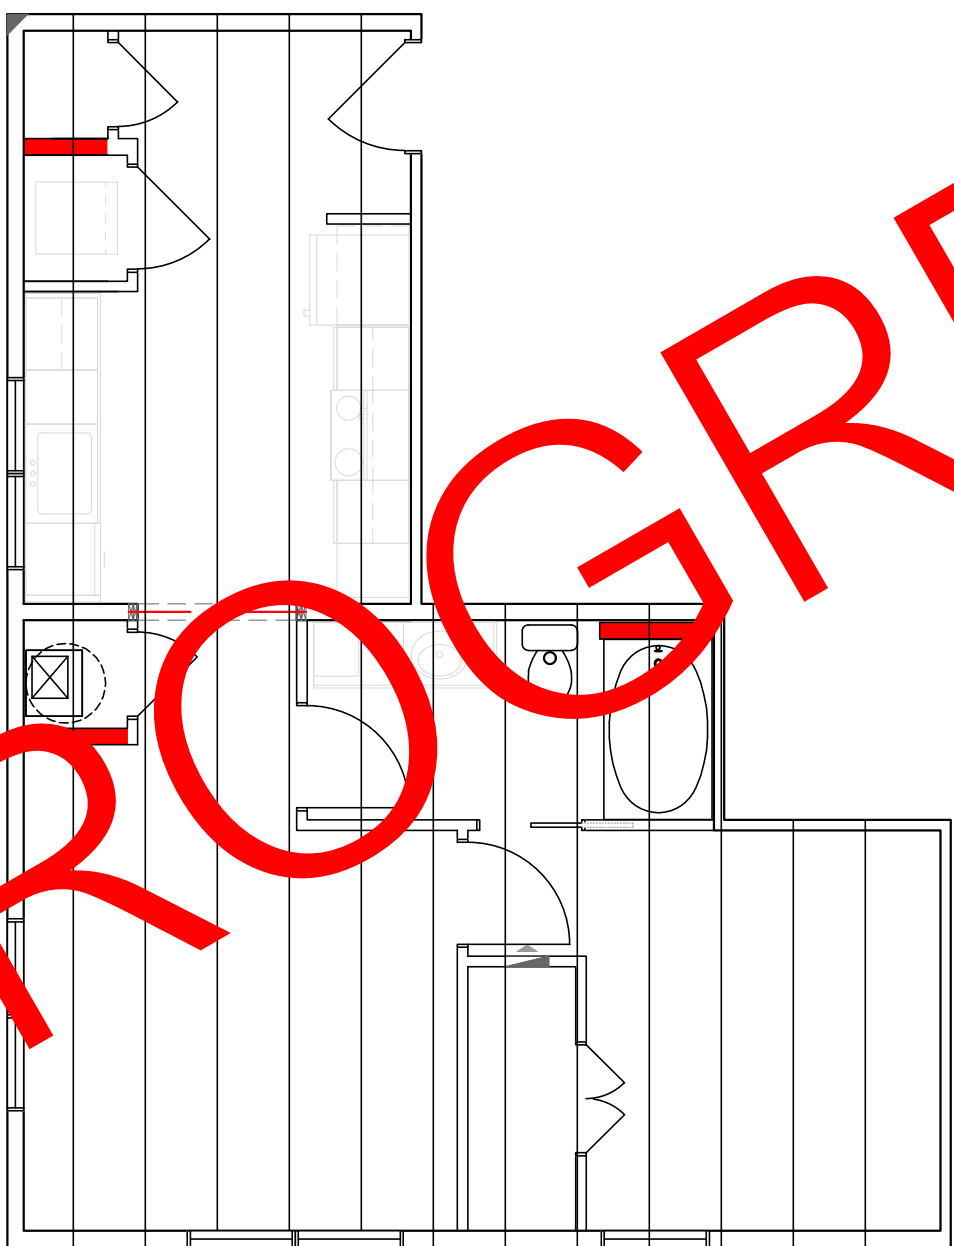

UNIT A1 FLOOR FRAMING  
Scale: 3/16" = 1'-0"


- == HIGH/LOW CLOSET RODS (T/SHELVES @ 42" / 84" AFF)
- SINGLE CLOSET ROD (T/SHELF @ 72" AFF). AT BEDROOM CLOSETS, INCLUDE ANGLED SHOE SHELF BELOW (14" AFF REAR, 7" AFF FRONT)
- \*\*\*\*\* INDICATES CROWN MOULDING
- ⚡ INDICATES ELECTRIC PANEL (SEE MEP)

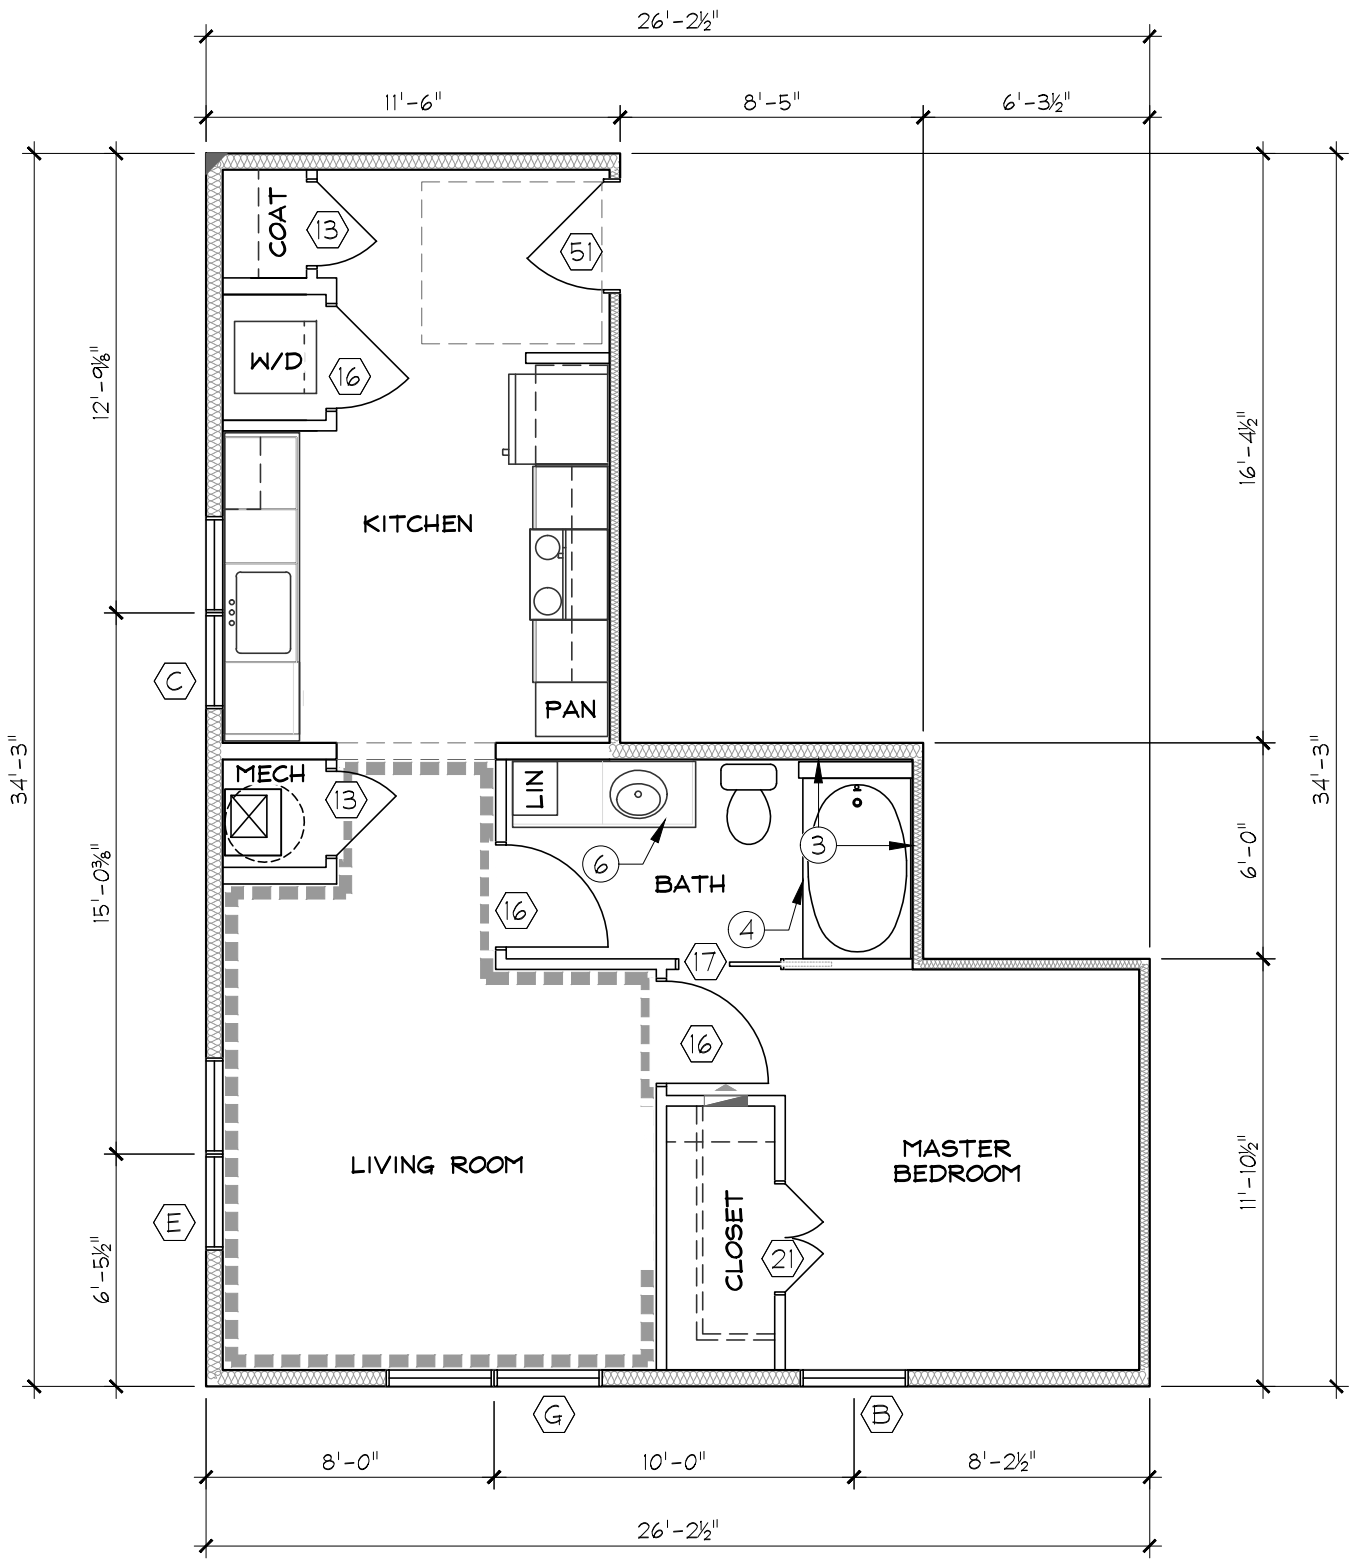

UNIT A1 FLOOR PLAN - HEATED SF (619) - QTY (3)  
Scale: 3/16" = 1'-0"

- UNIT WALL FRAMING NOTES:**
- UNSHADED WALLS ARE NON-BEARING (SPF STUD GRADE @ 16 OC).
  - INTERIOR NON-BEARING WALLS ARE 2x4 (UNO).
  - SEE FLOOR AND ROOF FRAMING PLANS FOR BEAM INFORMATION.
  - SEE SHEAR WALL PLANS FOR EXTERIOR SHEATHING TYPE & FASTENING.

- INDICATES BEARING WALL STUD SPECIFICATIONS. SEE G5.1 FOR SCHEDULE. COLOR SHOWN IN WALL INDICATES SPECS FOR THE LOWEST LEVEL ON WHICH THE UNIT OCCURS.
- INDICATES UNIT TYPE DOES NOT OCCUR AT LEVEL SHOWN.
- ▨ INDICATES WALL IS NON-BEARING AT LEVEL SHOWN.

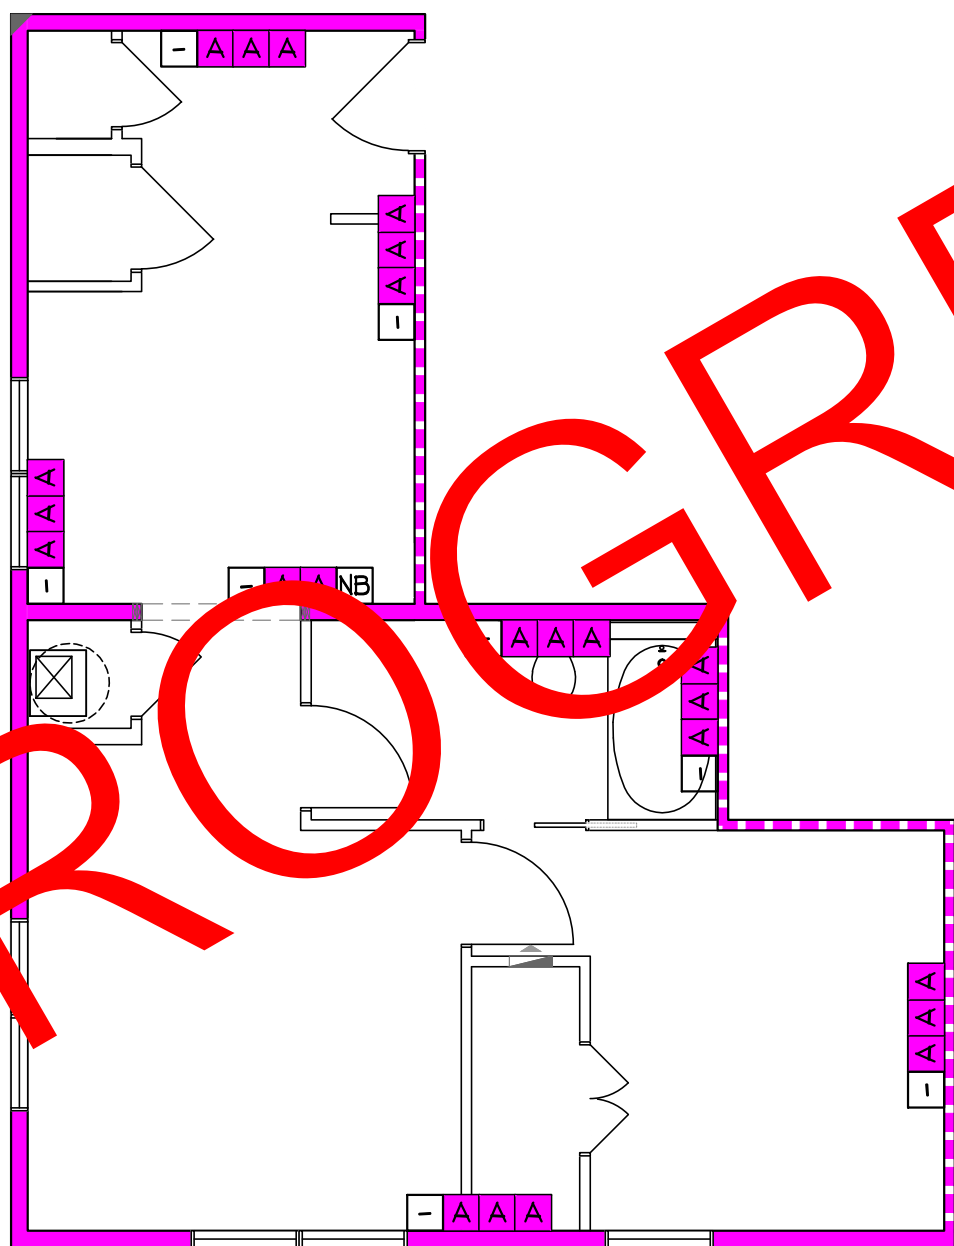

COMPLETE WALL FRAMING  
DIMENSIONS TO BE PROVIDED IN  
CONSTRUCTION RELEASE PLANS

UNIT A1 WALL FRAMING  
Scale: 3/16" = 1'-0"

- Ⓜ INDICATES DOOR OR WINDOW TYPE. SEE G5.1 & G5.2 FOR SCHEDULE. WHERE MULTIPLE TYPES ARE SHOWN, SEE FRAMING ELEVATIONS.
- INDICATES R13 BATTS @ 2x4 INTERIOR WALLS, R19 BATTS @ 2x6 EXTERIOR WALLS AND CORRIDOR WALLS.

- UNIT PLAN NOTES:**
1. ALL DIMENSIONS ARE TO FACE OF STUD OR CENTERLINE OF TRUSS (UNO).
  2. DOORS & WINDOWS ARE DIMENSIONED TO CENTER, CENTERED BETWEEN ADJACENT WALLS OR 3" AWAY FROM NEAREST WALL.
  3. SEE BUILDING FLOOR PLANS FOR OVERALL BUILDING LAYOUT AND SPECIFICATIONS.
  4. INDICATES REFERENCE POINT FOR STARTING DIMENSIONAL LAYOUT & UNIT ORIENTATION.
  5. ALL UNITS ARE 'TYPE B' (UNO). SEE BUILDING PLANS FOR UNITS COMPLYING WITH TYPE 'A' AND 'IAC' REQUIREMENTS. SEE G4.1- G4.2 FOR REQUIRED CLEARANCES AT FIXTURES, APPLIANCES, KITCHEN ISLANDS, ETC.
  6. UNIT FINISHES TO BE SELECTED BY OWNER.
  7. SEE U4.1-U4.4 FOR INTERIOR ELEVATIONS AT KITCHENS AND BATHS.
  8. SEE G0.1 FOR GENERAL NOTES.
  9. FLOOR ASSEMBLIES & FINISHES:
    - 9.1. INDICATES CARPET & PADDING OVER 1" GYP-CRETE OVER 3/4" SUBFLOOR OVER OPEN-WEB FLOOR TRUSSES WITH INSULATION, RESILIENT CHANNEL AND 5/8" GYPSUM CEILING (UNO). (UL #L521, STC 56, IIC 69).
    - 9.2. INDICATES VINYL PLANK OVER 3/4" GYP-CRETE OVER 1/2" SOUND MAT OVER 3/4" SUBFLOOR OVER OPEN-WEB FLOOR TRUSSES WITH INSULATION, RESILIENT CHANNEL AND 5/8" GYPSUM CEILING. (UL #L521, STC 56, IIC 56).
    - 9.3. INDICATES CERAMIC TILE OVER 3/4" GYP-CRETE OVER 1/2" SOUND MAT OVER 3/4" SUBFLOOR OVER OPEN-WEB FLOOR TRUSSES WITH INSULATION, RESILIENT CHANNEL AND 5/8" GYPSUM CEILING. (UL #L521, STC 56, IIC 54).

- KEY NOTES:**
- ① 18" DEEP OPEN WEB, METAL PLATE CONNECTED WOOD FLOOR TRUSSES SPACED @ 24" OC (UNO)
  - ② 2x6 KNEE WALL
  - ③ REQUIRES PRE-INSTALLED 5/8" TYPE 'X' GYP AT WALL AND/OR CEILING PRIOR TO COMPLETION OF FRAMING OR INSTALL OF FIXTURE TO MAINTAIN FIRE-RATING
  - ④ 36" x 60" TUB w/ SURROUND (UNO)
  - ⑤ 36" x 60" SHOWER BASE w/ SURROUND (UNO)
  - ⑥ VANITY CABINET & COUNTERTOP (SEE U4.4)
  - ⑦ 42" GUARD RAIL w/ BALUSTERS @ 4" OC (MAX) (SEE BLDG FLOOR PLANS & ELEVATIONS FOR UNITS W/OUT RAILING)
  - ⑧ 2x10's #2 SYP PT @ 16" OC

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**CHROMA II**  
**MIXED-USE DEVELOPMENT**  
(CONCEPT 2.3)


ST. LOUIS, MO

NO	REVISIONS	DATE

DRAWING TITLE  
UNIT PLANS: A1

PROJECT # 850	DRAWING NUMBER U1.3
DATE 02/22/19	DESIGN DEVELOPMENT


- LIGHT FIXTURE PLACEMENT:**
- PLACE LIGHTS AS SHOWN. ADJUST FOR STRUCTURE AS NEEDED WHILE MAINTAINING DESIGN INTENT.
  - SEE INTERIOR ELEVATIONS (U4 SHEETS) FOR VANITY DIMENSIONS AND CENTER FIXTURES ACCORDINGLY.

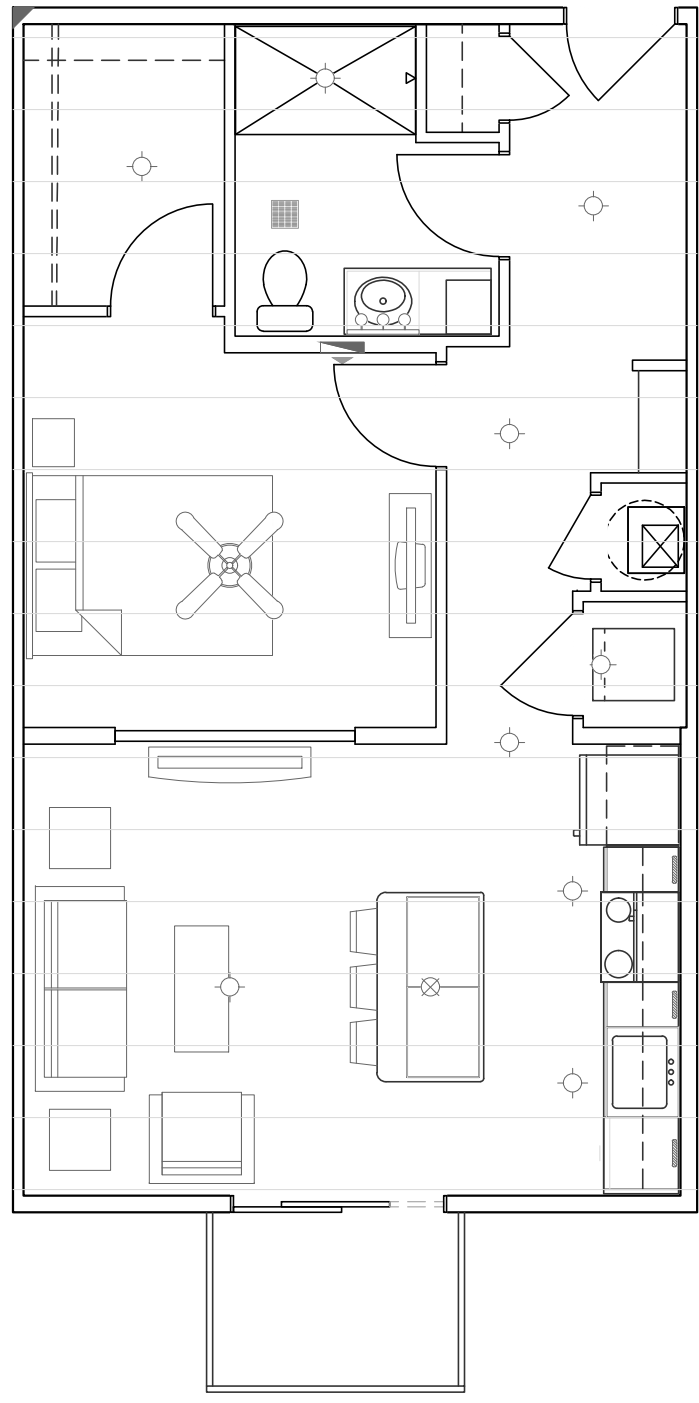

UNIT A2 LIGHT FIXTURE & FURNITURE PLACEMENT PLAN  
Scale: 3/16" = 1'-0"

- == HIGH/LOW CLOSET RODS (T/SHELVES @ 42" / 84" AFF)
- SINGLE CLOSET ROD (T/SHELF @ 72" AFF). AT BEDROOM CLOSETS, INCLUDE ANGLED SHOE SHELF BELOW (14" AFF REAR, 7" AFF FRONT)
- \*\*\*\*\* INDICATES CROWN MOULDING
- INDICATES ELECTRIC PANEL (SEE MEP)


- (#) INDICATES DOOR OR WINDOW TYPE. SEE G5.1 & G5.2 FOR SCHEDULE. WHERE MULTIPLE TYPES ARE SHOWN, SEE FRAMING ELEVATIONS.
- INDICATES R13 BATTS @ 2x4 INTERIOR WALLS, R19 BATTS @ 2x6 EXTERIOR WALLS AND CORRIDOR WALLS.

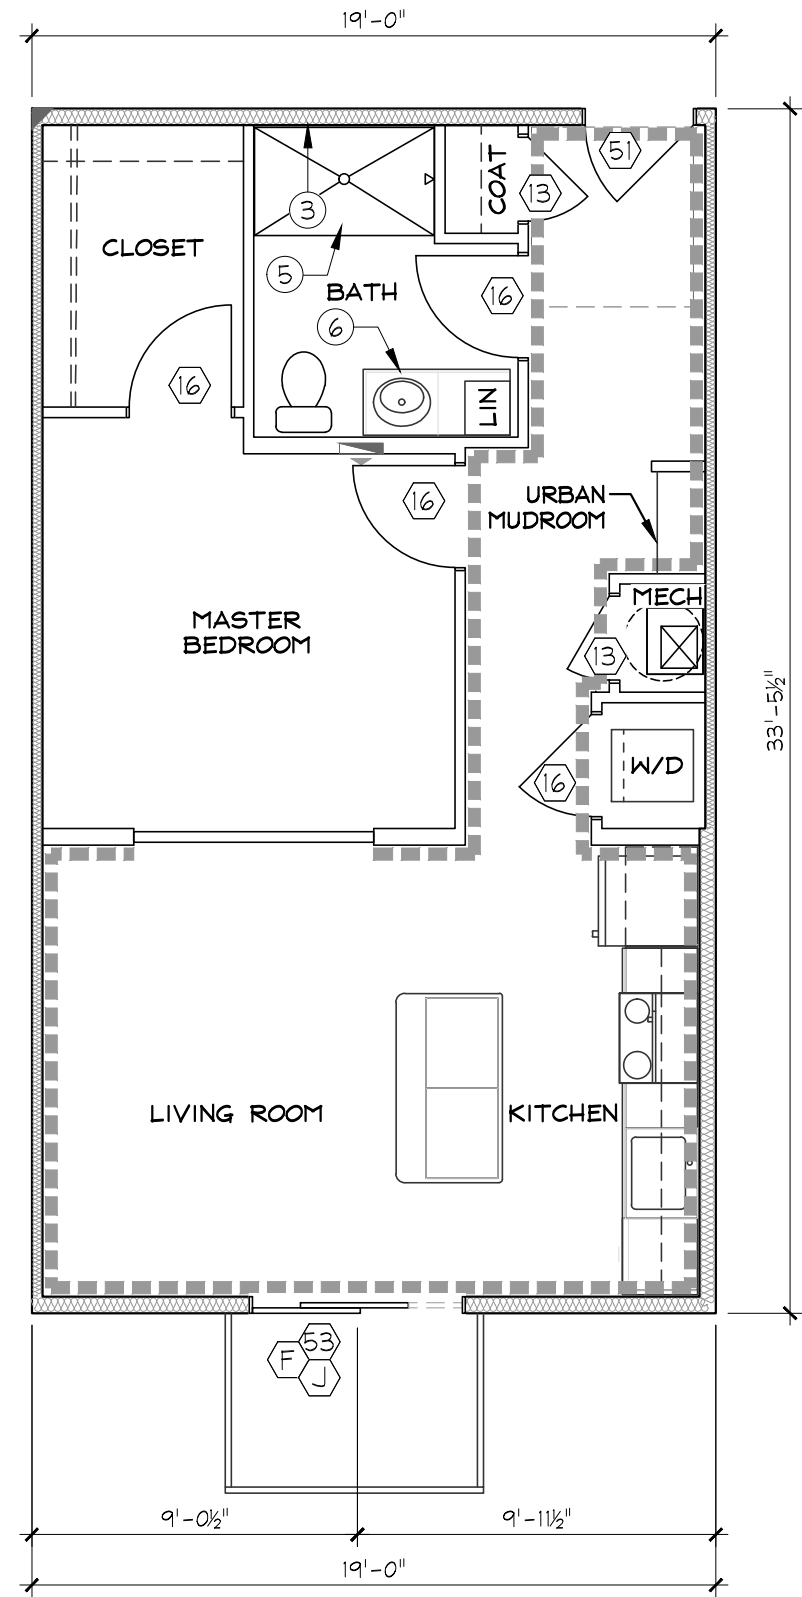

UNIT A2 FLOOR PLAN - HEATED SF (636) - QTY (9)  
Scale: 3/16" = 1'-0"

- UNIT FLOOR FRAMING NOTES:**
- PLAN SHOWS UNIT FLOOR SYSTEM AND WALLS BELOW.
  - VERIFY PLUMBING DRAIN LOCATIONS WITH CONTRACTOR AND ADJUST TRUSS SPACING AS REQUIRED.
  - SEE BUILDING FRAMING PLANS FOR CORRIDOR FRAMING & ADDITIONAL FRAMING DETAIL CALLOUTS.


- INDICATES WALL DESIGNATED FOR PLUMBING PENETRATIONS.
- INDICATES PLUMBING VENT (2" MAX I.D.), OFFSET FROM LIGHT FIXTURE 6" MINIMUM.
- INDICATES INTERIOR LOAD BEARING WALL (LEVELS 1-3). ALL UNIT PERIMETER WALLS ARE BEARING (UNO).
- INDICATES BEAM FOR TRUSS BEARING. SEE G5.1 FOR BEAM SCHEDULE.

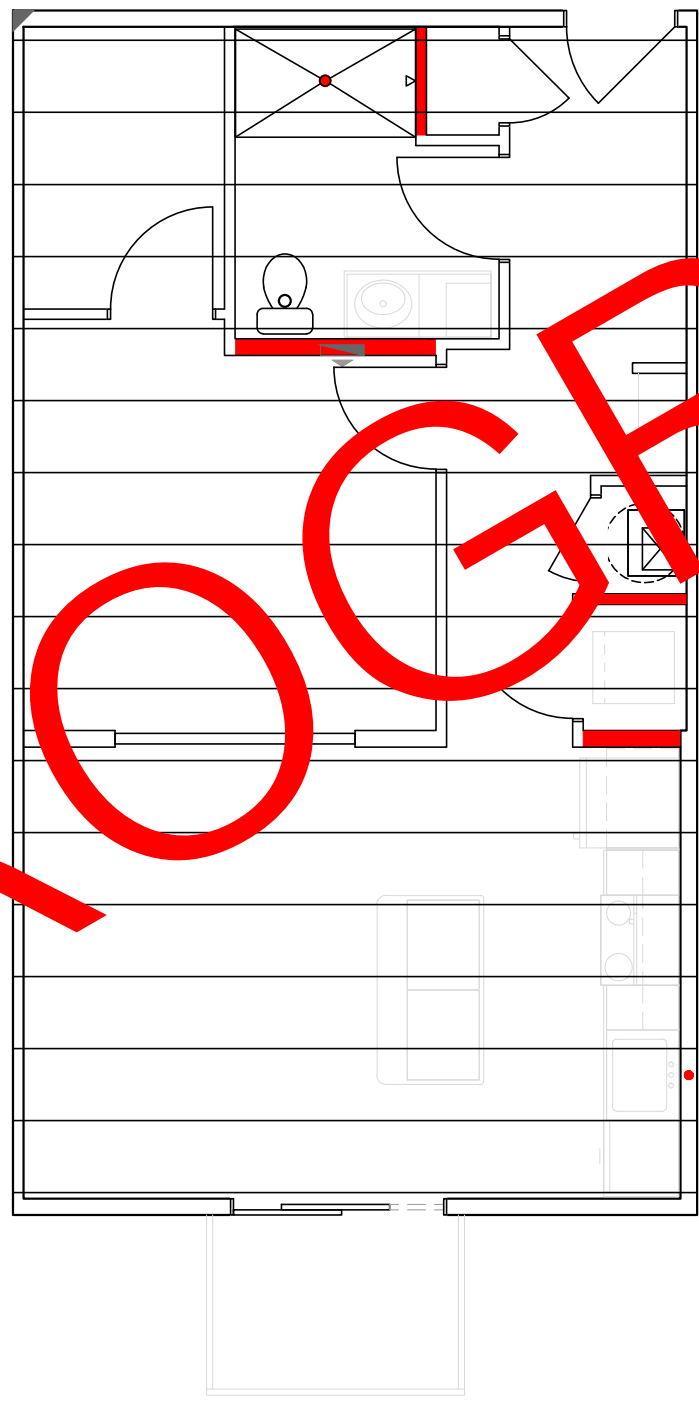

UNIT A2 FLOOR FRAMING  
Scale: 3/16" = 1'-0"

- UNIT WALL FRAMING NOTES:**
- UNSHADED WALLS ARE NON-BEARING (SPF STUD GRADE @ 16 OC).
  - INTERIOR NON-BEARING WALLS ARE 2x4 (UNO).
  - SEE FLOOR AND ROOF FRAMING PLANS FOR BEAM INFORMATION.
  - SEE SHEAR WALL PLANS FOR EXTERIOR SHEATHING TYPE & FASTENING.

- INDICATES BEARING WALL STUD SPECIFICATIONS. SEE G5.1 FOR SCHEDULE. COLOR SHOWN IN WALL INDICATES SPECS FOR THE LOWEST LEVEL ON WHICH THE UNIT OCCURS.
- INDICATES UNIT TYPE DOES NOT OCCUR AT LEVEL SHOWN.
- INDICATES WALL IS NON-BEARING AT LEVEL SHOWN.

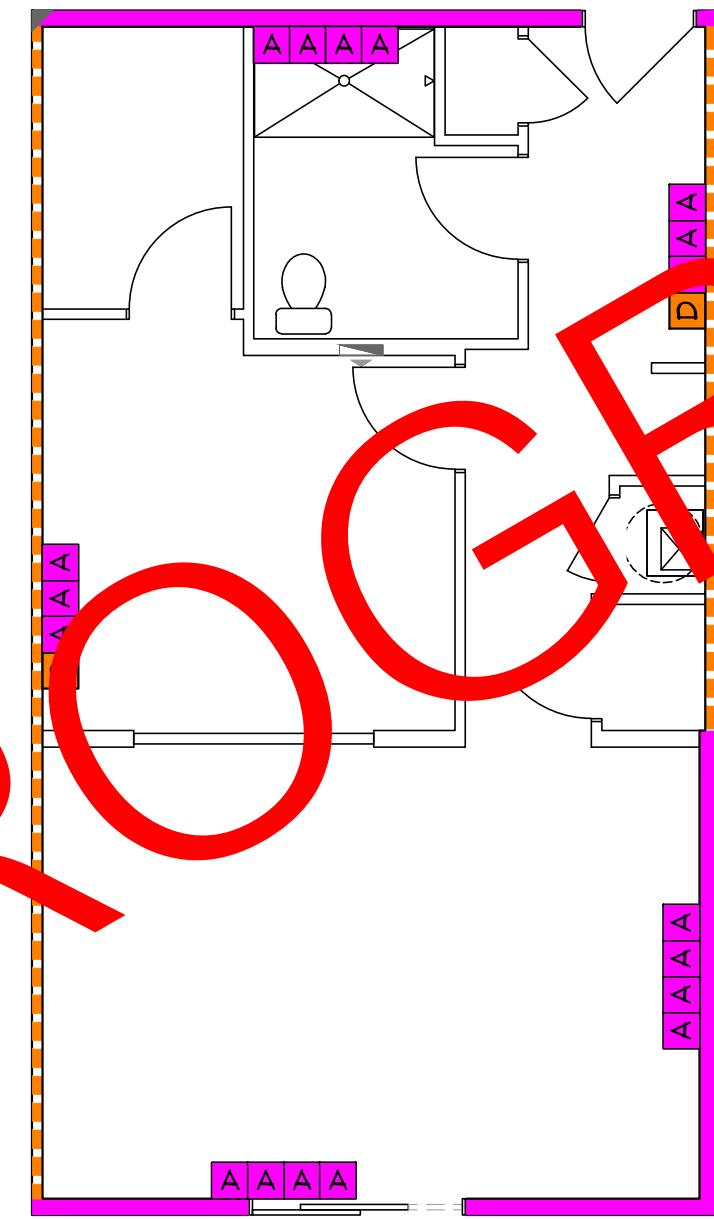

COMPLETE WALL FRAMING  
DIMENSIONS TO BE PROVIDED IN  
CONSTRUCTION RELEASE PLANS

UNIT A2 WALL FRAMING  
Scale: 3/16" = 1'-0"

- UNIT PLAN NOTES:**
- ALL DIMENSIONS ARE TO FACE OF STUD OR CENTERLINE OF TRUSS (UNO).
  - DOORS & WINDOWS ARE DIMENSIONED TO CENTER, CENTERED BETWEEN ADJACENT WALLS OR 3" AWAY FROM NEAREST WALL.
  - SEE BUILDING FLOOR PLANS FOR OVERALL BUILDING LAYOUT AND SPECIFICATIONS.
  - INDICATES REFERENCE POINT FOR STARTING DIMENSIONAL LAYOUT & UNIT ORIENTATION.
  - ALL UNITS ARE 'TYPE B' (UNO). SEE BUILDING PLANS FOR UNITS COMPLYING WITH 'TYPE A' AND 'IAC' REQUIREMENTS. SEE G4.1- G4.2 FOR REQUIRED CLEARANCES AT FIXTURES, APPLIANCES, KITCHEN ISLANDS, ETC.
  - UNIT FINISHES TO BE SELECTED BY OWNER.
  - SEE U4.1-U4.4 FOR INTERIOR ELEVATIONS AT KITCHENS AND BATHS.
  - SEE G0.1 FOR GENERAL NOTES.
  - FLOOR ASSEMBLIES & FINISHES:
    - INDICATES CARPET & PADDING OVER 1" GYP-CRETE OVER 3/4" SUBFLOOR OVER OPEN-WEB FLOOR TRUSSES WITH INSULATION, RESILIENT CHANNEL AND 5/8" GYPSUM CEILING (UNO). (UL #L521, STC 56, IIC 69).
    - INDICATES VINYL PLANK OVER 3/4" GYP-CRETE OVER 3/4" SOUND MAT OVER 3/4" SUBFLOOR OVER OPEN-WEB FLOOR TRUSSES WITH INSULATION, RESILIENT CHANNEL AND 5/8" GYPSUM CEILING. (UL #L521, STC 56, IIC 56).
    - INDICATES CERAMIC TILE OVER 3/4" GYP-CRETE OVER 3/4" SOUND MAT OVER 3/4" SUBFLOOR OVER OPEN-WEB FLOOR TRUSSES WITH INSULATION, RESILIENT CHANNEL AND 5/8" GYPSUM CEILING. (UL #L521, STC 56, IIC 54).

- KEY NOTES:**
- 18" DEEP OPEN WEB, METAL PLATE CONNECTED WOOD FLOOR TRUSSES SPACED @ 24" OC (UNO)
  - 2x6 KNEE WALL
  - REQUIRES PRE-INSTALLED 5/8" TYPE 'X' GYP AT WALL AND/OR CEILING PRIOR TO COMPLETION OF FRAMING OR INSTALL OF FIXTURE TO MAINTAIN FIRE-RATING
  - 36" x 60" TUB w/ SURROUND (UNO)
  - 36" x 60" SHOWER BASE w/ SURROUND (UNO)
  - VANITY CABINET & COUNTERTOP (SEE U4.4)
  - 42" GUARD RAIL w/ BALUSTERS @ 4" OC (MAX) (SEE BLDG FLOOR PLANS & ELEVATIONS FOR UNITS W/OUT RAILING)
  - 2x10's #2 SYP PT @ 16" OC

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**CHROMA II**  
**MIXED-USE DEVELOPMENT**  
(CONCEPT 2.3)


ST. LOUIS, MO

NO	REVISIONS	DATE

DRAWING TITLE  
UNIT PLANS: A2

PROJECT # 850	DRAWING NUMBER U1.4
DATE 02/22/19	DESIGN DEVELOPMENT


- LIGHT FIXTURE PLACEMENT:**
- PLACE LIGHTS AS SHOWN. ADJUST FOR STRUCTURE AS NEEDED WHILE MAINTAINING DESIGN INTENT.
  - SEE INTERIOR ELEVATIONS (U4 SHEETS) FOR VANITY DIMENSIONS AND CENTER FIXTURES ACCORDINGLY.

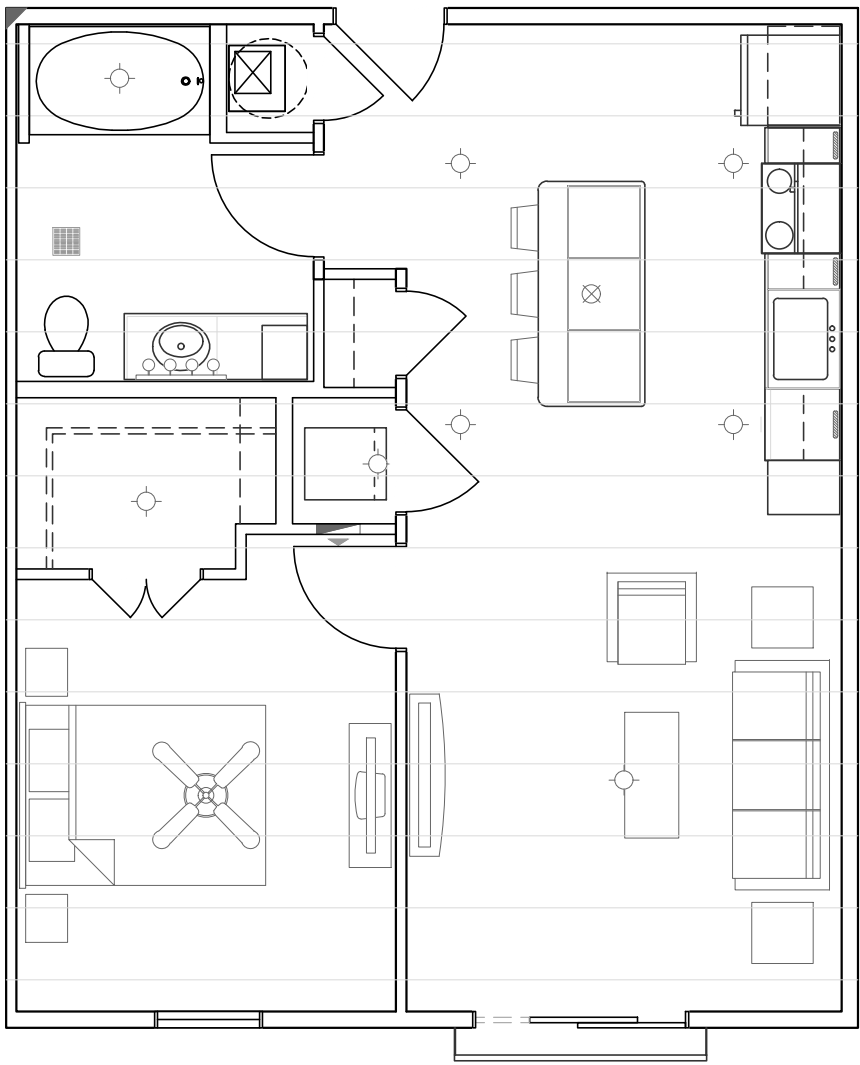

UNIT A3 LIGHT FIXTURE & FURNITURE PLACEMENT PLAN  
Scale: 3/16" = 1'-0"

- === HIGH/LOW CLOSET RODS (T/SHELVES @ 42" / 84" AFF)
- SINGLE CLOSET ROD (T/SHELF @ 72" AFF). AT BEDROOM CLOSETS, INCLUDE ANGLED SHOE SHELF BELOW (14" AFF REAR, 7" AFF FRONT)
- \*\*\*\*\* INDICATES CROWN MOULDING
- ⎓ INDICATES ELECTRIC PANEL (SEE MEP)

- Ⓜ INDICATES DOOR OR WINDOW TYPE. SEE G5.1 & G5.2 FOR SCHEDULE. WHERE MULTIPLE TYPES ARE SHOWN, SEE FRAMING ELEVATIONS.
- ⓂⓂⓂⓂ INDICATES R13 BATTS @ 2x4 INTERIOR WALLS, R19 BATTS @ 2x6 EXTERIOR WALLS AND CORRIDOR WALLS.

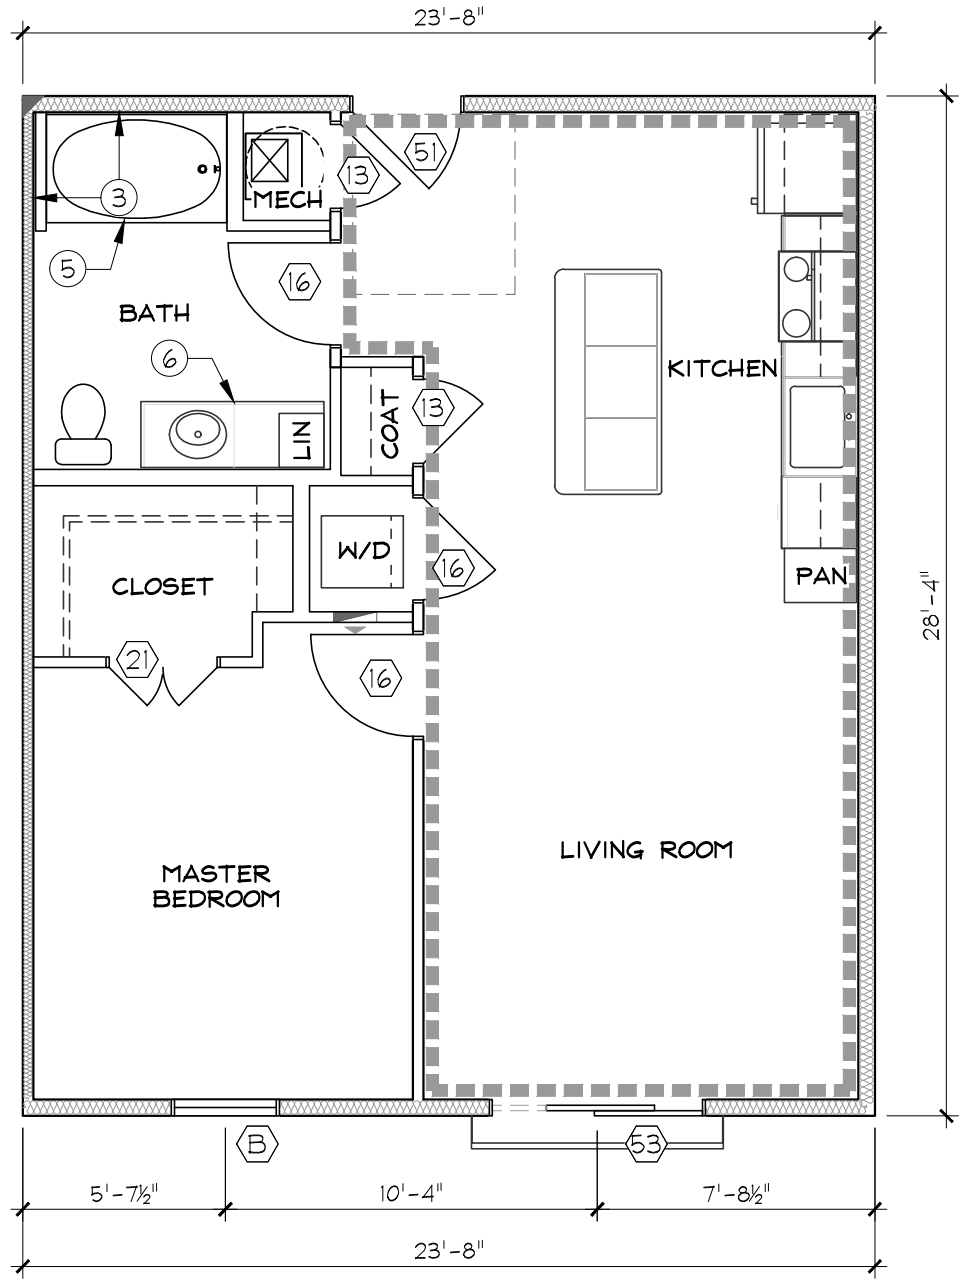

UNIT A3 FLOOR PLAN - HEATED SF (671) - QTY (3)  
Scale: 3/16" = 1'-0"

- UNIT FLOOR FRAMING NOTES:**
- PLAN SHOWS UNIT FLOOR SYSTEM AND WALLS BELOW.
  - VERIFY PLUMBING DRAIN LOCATIONS WITH CONTRACTOR AND ADJUST TRUSS SPACING AS REQUIRED.
  - SEE BUILDING FRAMING PLANS FOR CORRIDOR FRAMING & ADDITIONAL FRAMING DETAIL CALLOUTS.


- INDICATES WALL DESIGNATED FOR PLUMBING PENETRATIONS.
- INDICATES PLUMBING VENT (2" MAX I.D.), OFFSET FROM LIGHT FIXTURE 6" MINIMUM.
- ▨ INDICATES INTERIOR LOAD BEARING WALL (LEVELS 1-3). ALL UNIT PERIMETER WALLS ARE BEARING (UNO).
- ◊ INDICATES BEAM FOR TRUSS BEARING. SEE G5.1 FOR BEAM SCHEDULE.



UNIT A3 FLOOR FRAMING  
Scale: 3/16" = 1'-0"

- UNIT WALL FRAMING NOTES:**
- UNSHADED WALLS ARE NON-BEARING (SPF STUD GRADE @ 16 OC).
  - INTERIOR NON-BEARING WALLS ARE 2x4 (UNO).
  - SEE FLOOR AND ROOF FRAMING PLANS FOR BEAM INFORMATION.
  - SEE SHEAR WALL PLANS FOR EXTERIOR SHEATHING TYPE & FASTENING.

- 3 FLOOR(S) ABOVE  
2 FLOOR(S) ABOVE  
1 FLOOR(S) ABOVE  
0 FLOOR(S) ABOVE
- INDICATES BEARING WALL STUD SPECIFICATIONS. SEE G5.1 FOR SCHEDULE. COLOR SHOWN IN WALL INDICATES SPECS FOR THE LOWEST LEVEL ON WHICH THE UNIT OCCURS.
- INDICATES UNIT TYPE DOES NOT OCCUR AT LEVEL SHOWN.
- ▢ INDICATES WALL IS NON-BEARING AT LEVEL SHOWN.

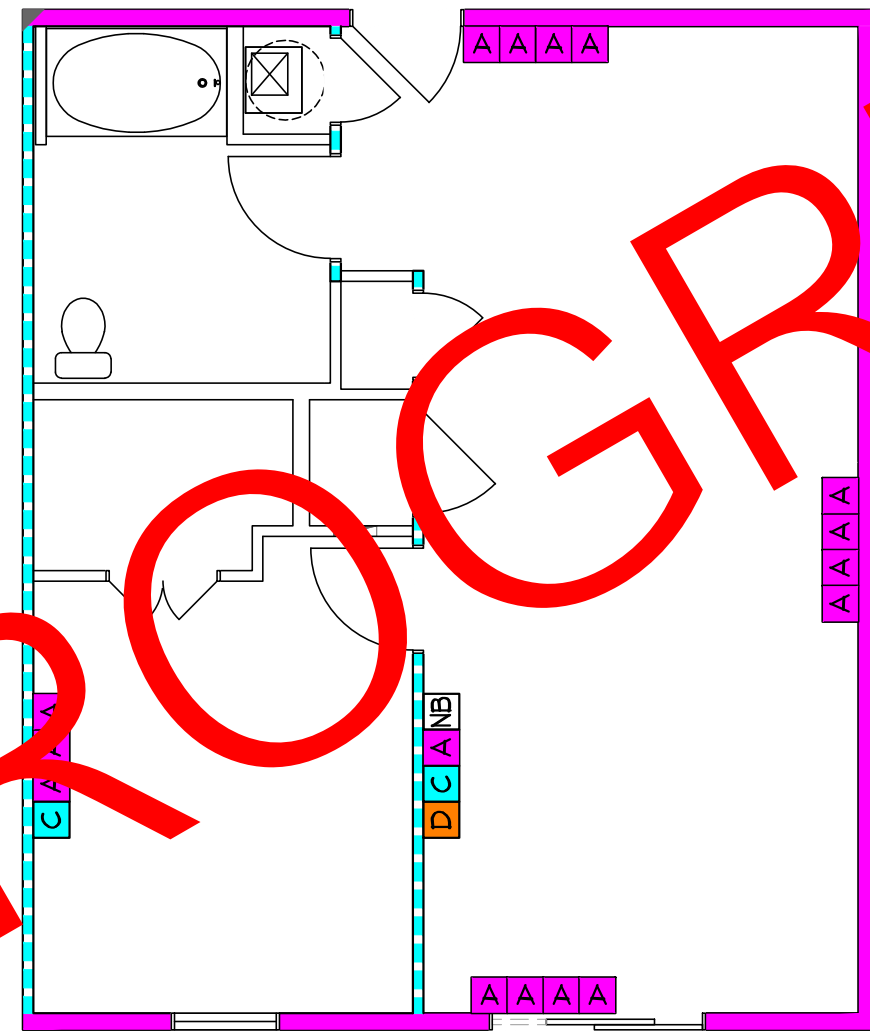

COMPLETE WALL FRAMING  
DIMENSIONS TO BE PROVIDED IN  
CONSTRUCTION RELEASE PLANS

UNIT A3 WALL FRAMING  
Scale: 3/16" = 1'-0"

- UNIT PLAN NOTES:**
1. ALL DIMENSIONS ARE TO FACE OF STUD OR CENTERLINE OF TRUSS (UNO).
  2. DOORS & WINDOWS ARE DIMENSIONED TO CENTER, CENTERED BETWEEN ADJACENT WALLS OR 3" AWAY FROM NEAREST WALL.
  3. SEE BUILDING FLOOR PLANS FOR OVERALL BUILDING LAYOUT AND SPECIFICATIONS.
  4. ⏏ INDICATES REFERENCE POINT FOR STARTING DIMENSIONAL LAYOUT & UNIT ORIENTATION.
  5. ALL UNITS ARE 'TYPE B' (UNO). SEE BUILDING PLANS FOR UNITS COMPLYING WITH TYPE 'A' AND 'IAC' REQUIREMENTS. SEE G4.1- G4.2 FOR REQUIRED CLEARANCES AT FIXTURES, APPLIANCES, KITCHEN ISLANDS, ETC.
  6. UNIT FINISHES TO BE SELECTED BY OWNER.
  7. SEE U4.1-U4.4 FOR INTERIOR ELEVATIONS AT KITCHENS AND BATHS.
  8. SEE G0.1 FOR GENERAL NOTES.
  9. FLOOR ASSEMBLIES & FINISHES:
    - 9.1. ▨ INDICATES CARPET & PADDING OVER 1" GYP-CRETE OVER 3/4" SUBFLOOR OVER OPEN-WEB FLOOR TRUSSES WITH INSULATION, RESILIENT CHANNEL AND 5/8" GYPSUM CEILING (UNO). (UL #L521, STC 56, IIC 69).
    - 9.2. ▨ INDICATES VINYL PLANK OVER 3/4" GYP-CRETE OVER 1/2" SOUND MAT OVER 3/4" SUBFLOOR OVER OPEN-WEB FLOOR TRUSSES WITH INSULATION, RESILIENT CHANNEL AND 5/8" GYPSUM CEILING. (UL #L521, STC 56, IIC 56).
    - 9.3. ▨ INDICATES CERAMIC TILE OVER 3/4" GYP-CRETE OVER 1/2" SOUND MAT OVER 3/4" SUBFLOOR OVER OPEN-WEB FLOOR TRUSSES WITH INSULATION, RESILIENT CHANNEL AND 5/8" GYPSUM CEILING. (UL #L521, STC 56, IIC 54).

- KEY NOTES:**
- ① 18" DEEP OPEN WEB, METAL PLATE CONNECTED WOOD FLOOR TRUSSES SPACED @ 24" OC (UNO)
  - ② 2x6 KNEE WALL
  - ③ REQUIRES PRE-INSTALLED 5/8" TYPE 'X' GYP AT WALL AND/OR CEILING PRIOR TO COMPLETION OF FRAMING OR INSTALL OF FIXTURE TO MAINTAIN FIRE-RATING
  - ④ 36" x 60" TUB w/ SURROUND (UNO)
  - ⑤ 36" x 60" SHOWER BASE w/ SURROUND (UNO)
  - ⑥ VANITY CABINET & COUNTERTOP (SEE U4.4)
  - ⑦ 42" GUARD RAIL w/ BALUSTERS @ 4" OC (MAX) (SEE BLDG FLOOR PLANS & ELEVATIONS FOR UNITS W/OUT RAILING)
  - ⑧ 2x10's #2 SYP PT @ 16" OC

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**CHROMA II**  
**MIXED-USE DEVELOPMENT**  
(CONCEPT 2.3)


ST. LOUIS, MO

NO	REVISIONS	DATE

DRAWING TITLE  
UNIT PLANS: A3


PROJECT #	DRAWING NUMBER
850	U1.5
DATE	DESIGN DEVELOPMENT
02/22/19	

- LIGHT FIXTURE PLACEMENT:**
- PLACE LIGHTS AS SHOWN. ADJUST FOR STRUCTURE AS NEEDED WHILE MAINTAINING DESIGN INTENT.
  - SEE INTERIOR ELEVATIONS (U4 SHEETS) FOR VANITY DIMENSIONS AND CENTER FIXTURES ACCORDINGLY.

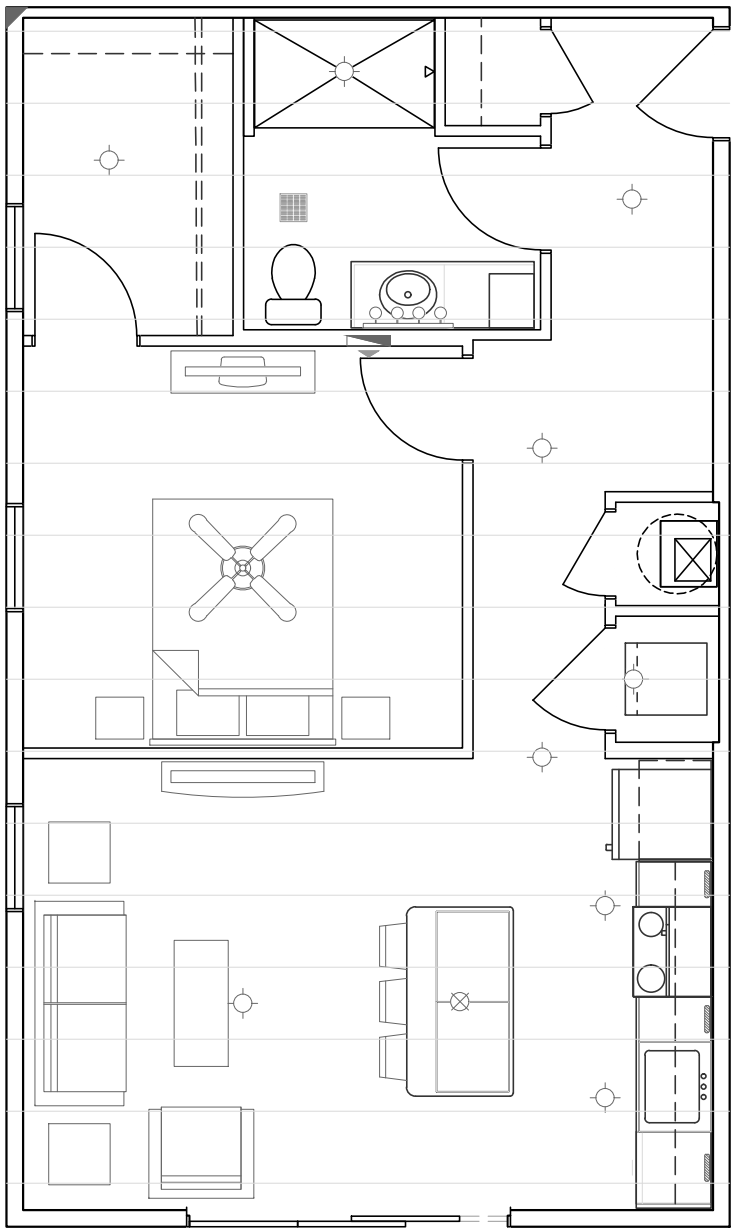


UNIT A4 LIGHT FIXTURE & FURNITURE PLACEMENT PLAN  
Scale: 3/16" = 1'-0"

- UNIT FLOOR FRAMING NOTES:**
- PLAN SHOWS UNIT FLOOR SYSTEM AND WALLS BELOW.
  - VERIFY PLUMBING DRAIN LOCATIONS WITH CONTRACTOR AND ADJUST TRUSS SPACING AS REQUIRED.
  - SEE BUILDING FRAMING PLANS FOR CORRIDOR FRAMING & ADDITIONAL FRAMING DETAIL CALLOUTS.

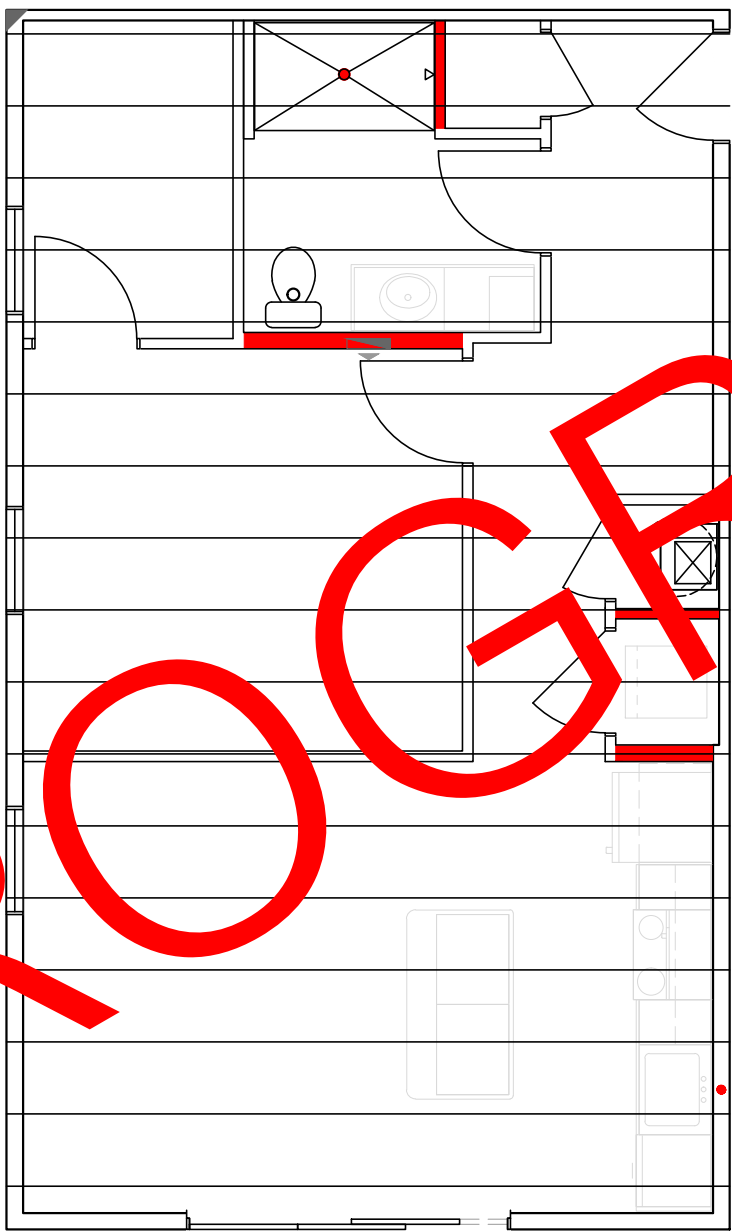

UNIT A4 FLOOR FRAMING  
Scale: 3/16" = 1'-0"

- === HIGH/LOW CLOSET RODS (T/SHELVES @ 42" / 84" AFF)
- SINGLE CLOSET ROD (T/SHELF @ 72" AFF). AT BEDROOM CLOSETS, INCLUDE ANGLED SHOE SHELF BELOW (14" AFF REAR, 7" AFF FRONT)
- \*\*\*\*\* INDICATES CROWN MOULDING
- INDICATES ELECTRIC PANEL (SEE MEP)

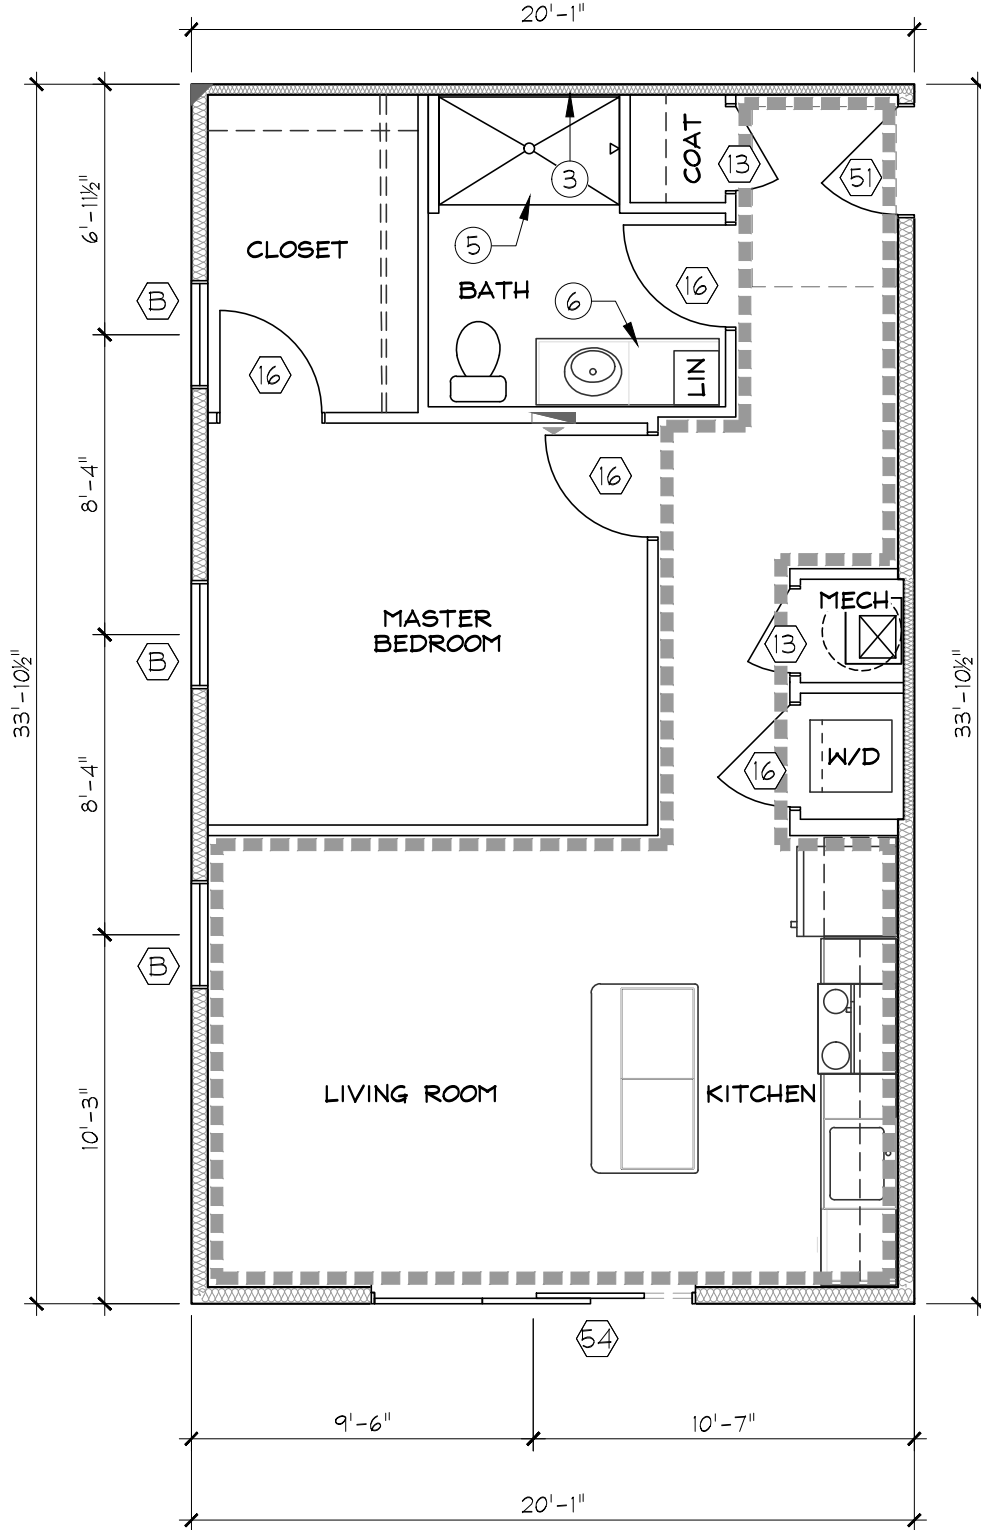

UNIT A4 FLOOR PLAN - HEATED SF (695) - QTY (3)  
Scale: 3/16" = 1'-0"


- Ⓜ INDICATES DOOR OR WINDOW TYPE. SEE G5.1 & G5.2 FOR SCHEDULE. WHERE MULTIPLE TYPES ARE SHOWN, SEE FRAMING ELEVATIONS.
- Ⓜ INDICATES R13 BATTS @ 2x4 INTERIOR WALLS, R19 BATTS @ 2x6 EXTERIOR WALLS AND CORRIDOR WALLS.

- UNIT PLAN NOTES:**
1. ALL DIMENSIONS ARE TO FACE OF STUD OR CENTERLINE OF TRUSS (UNO).
  2. DOORS & WINDOWS ARE DIMENSIONED TO CENTER, CENTERED BETWEEN ADJACENT WALLS OR 3" AWAY FROM NEAREST WALL.
  3. SEE BUILDING FLOOR PLANS FOR OVERALL BUILDING LAYOUT AND SPECIFICATIONS.
  4. ■ INDICATES REFERENCE POINT FOR STARTING DIMENSIONAL LAYOUT & UNIT ORIENTATION.
  5. ALL UNITS ARE 'TYPE B' (UNO). SEE BUILDING PLANS FOR UNITS COMPLYING WITH 'TYPE A' AND 'IAC' REQUIREMENTS. SEE G4.1- G4.2 FOR REQUIRED CLEARANCES AT FIXTURES, APPLIANCES, KITCHEN ISLANDS, ETC.
  6. UNIT FINISHES TO BE SELECTED BY OWNER.
  7. SEE U4.1-U4.4 FOR INTERIOR ELEVATIONS AT KITCHENS AND BATHS.
  8. SEE G0.1 FOR GENERAL NOTES.
  9. FLOOR ASSEMBLIES & FINISHES:
    - 9.1. ■ INDICATES CARPET & PADDING OVER 1" GYP-CRETE OVER 3/4" SUBFLOOR OVER OPEN-WEB FLOOR TRUSSES WITH INSULATION, RESILIENT CHANNEL AND 5/8" GYPSUM CEILING (UNO). (UL #L521, STC 56, IIC 69).
    - 9.2. ■ INDICATES VINYL PLANK OVER 3/4" GYP-CRETE OVER 1/2" SOUND MAT OVER 3/4" SUBFLOOR OVER OPEN-WEB FLOOR TRUSSES WITH INSULATION, RESILIENT CHANNEL AND 5/8" GYPSUM CEILING. (UL #L521, STC 56, IIC 56).
    - 9.3. ■ INDICATES CERAMIC TILE OVER 3/4" GYP-CRETE OVER 1/2" SOUND MAT OVER 3/4" SUBFLOOR OVER OPEN-WEB FLOOR TRUSSES WITH INSULATION, RESILIENT CHANNEL AND 5/8" GYPSUM CEILING. (UL #L521, STC 56, IIC 54).

- KEY NOTES:**
- ① 18" DEEP OPEN WEB, METAL PLATE CONNECTED WOOD FLOOR TRUSSES SPACED @ 24" OC (UNO)
  - ② 2x6 KNEE WALL
  - ③ REQUIRES PRE-INSTALLED 5/8" TYPE 'X' GYP AT WALL AND/OR CEILING PRIOR TO COMPLETION OF FRAMING OR INSTALL OF FIXTURE TO MAINTAIN FIRE-RATING
  - ④ 36" x 60" TUB w/ SURROUND (UNO)
  - ⑤ 36" x 60" SHOWER BASE w/ SURROUND (UNO)
  - ⑥ VANITY CABINET & COUNTERTOP (SEE U4.4)
  - ⑦ 42" GUARD RAIL w/ BALUSTERS @ 4" OC (MAX) (SEE BLDG FLOOR PLANS & ELEVATIONS FOR UNITS W/OUT RAILING)
  - ⑧ 2x10's #2 SYP PT @ 16" OC

- UNIT WALL FRAMING NOTES:**
- UNSHADED WALLS ARE NON-BEARING (SPF STUD GRADE @ 16 OC).
  - INTERIOR NON-BEARING WALLS ARE 2x4 (UNO).
  - SEE FLOOR AND ROOF FRAMING PLANS FOR BEAM INFORMATION.
  - SEE SHEAR WALL PLANS FOR EXTERIOR SHEATHING TYPE & FASTENING.

- INDICATES BEARING WALL STUD SPECIFICATIONS. SEE G5.1 FOR SCHEDULE. COLOR SHOWN IN WALL INDICATES SPECS FOR THE LOWEST LEVEL ON WHICH THE UNIT OCCURS.
- INDICATES UNIT TYPE DOES NOT OCCUR AT LEVEL SHOWN.
- INDICATES WALL IS NON-BEARING AT LEVEL SHOWN.

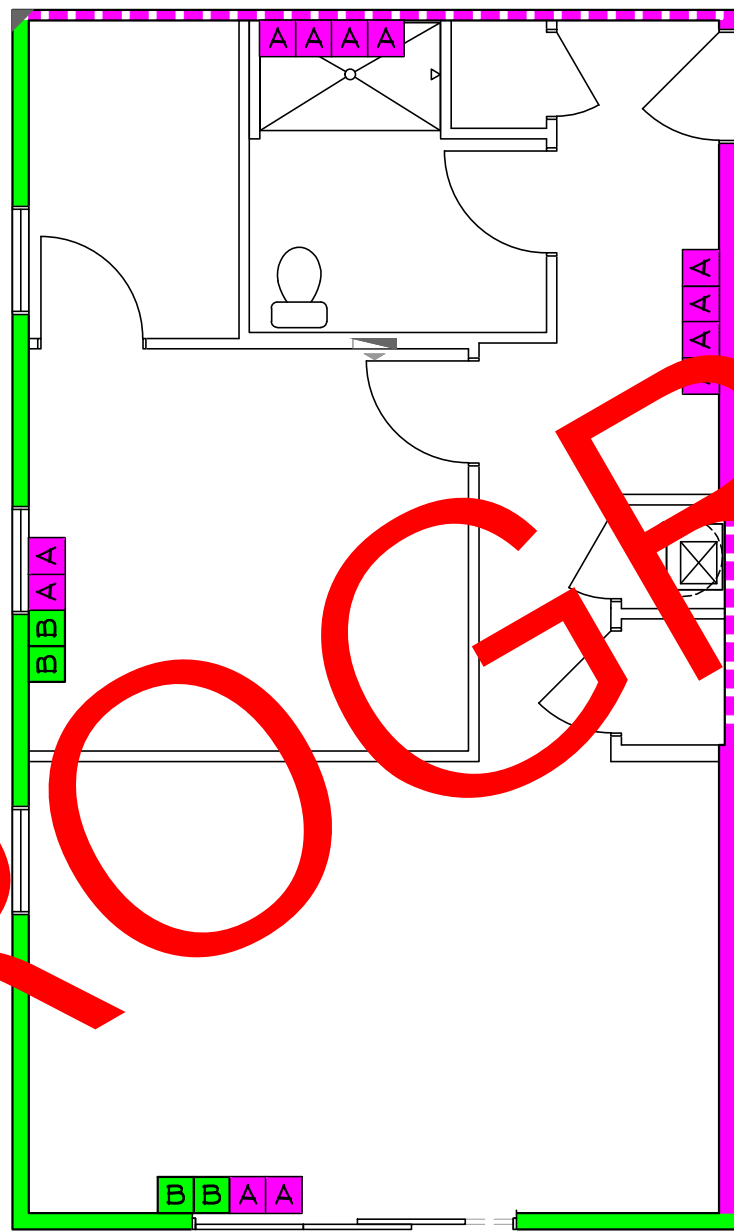

COMPLETE WALL FRAMING  
DIMENSIONS TO BE PROVIDED IN  
CONSTRUCTION RELEASE PLANS

UNIT A4 WALL FRAMING  
Scale: 3/16" = 1'-0"

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**CHROMA II**  
**MIXED-USE DEVELOPMENT**  
(CONCEPT 2.3)


ST. LOUIS, MO

NO	REVISIONS	DATE

DRAWING TITLE  
UNIT PLANS: A4

PROJECT # 850	DRAWING NUMBER U1.6
DATE 02/22/19	DESIGN DEVELOPMENT


- LIGHT FIXTURE PLACEMENT:**
- PLACE LIGHTS AS SHOWN. ADJUST FOR STRUCTURE AS NEEDED WHILE MAINTAINING DESIGN INTENT.
  - SEE INTERIOR ELEVATIONS (U4 SHEETS) FOR VANITY DIMENSIONS AND CENTER FIXTURES ACCORDINGLY.

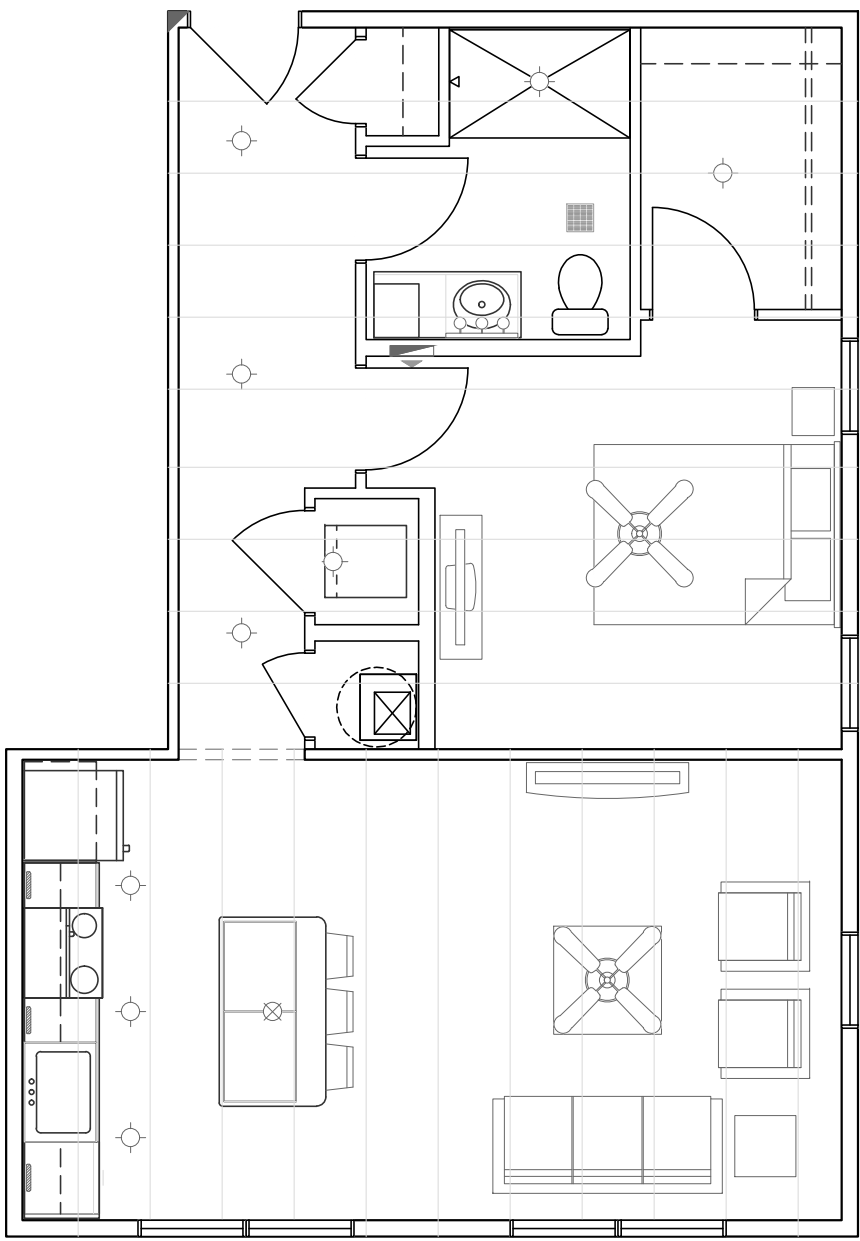

UNIT A5 LIGHT FIXTURE & FURNITURE PLACEMENT PLAN  
Scale: 3/16" = 1'-0"


- UNIT FLOOR FRAMING NOTES:**
- PLAN SHOWS UNIT FLOOR SYSTEM AND WALLS BELOW.
  - VERIFY PLUMBING DRAIN LOCATIONS WITH CONTRACTOR AND ADJUST TRUSS SPACING AS REQUIRED.
  - SEE BUILDING FRAMING PLANS FOR CORRIDOR FRAMING & ADDITIONAL FRAMING DETAIL CALLOUTS.

- INDICATES WALL DESIGNATED FOR PLUMBING PENETRATIONS.
- INDICATES PLUMBING VENT (2" MAX I.D.), OFFSET FROM LIGHT FIXTURE 6" MINIMUM.
- ▨ INDICATES INTERIOR LOAD BEARING WALL (LEVELS 1-3). ALL UNIT PERIMETER WALLS ARE BEARING (UNO).
- ◊ INDICATES BEAM FOR TRUSS BEARING. SEE G5.1 FOR BEAM SCHEDULE.

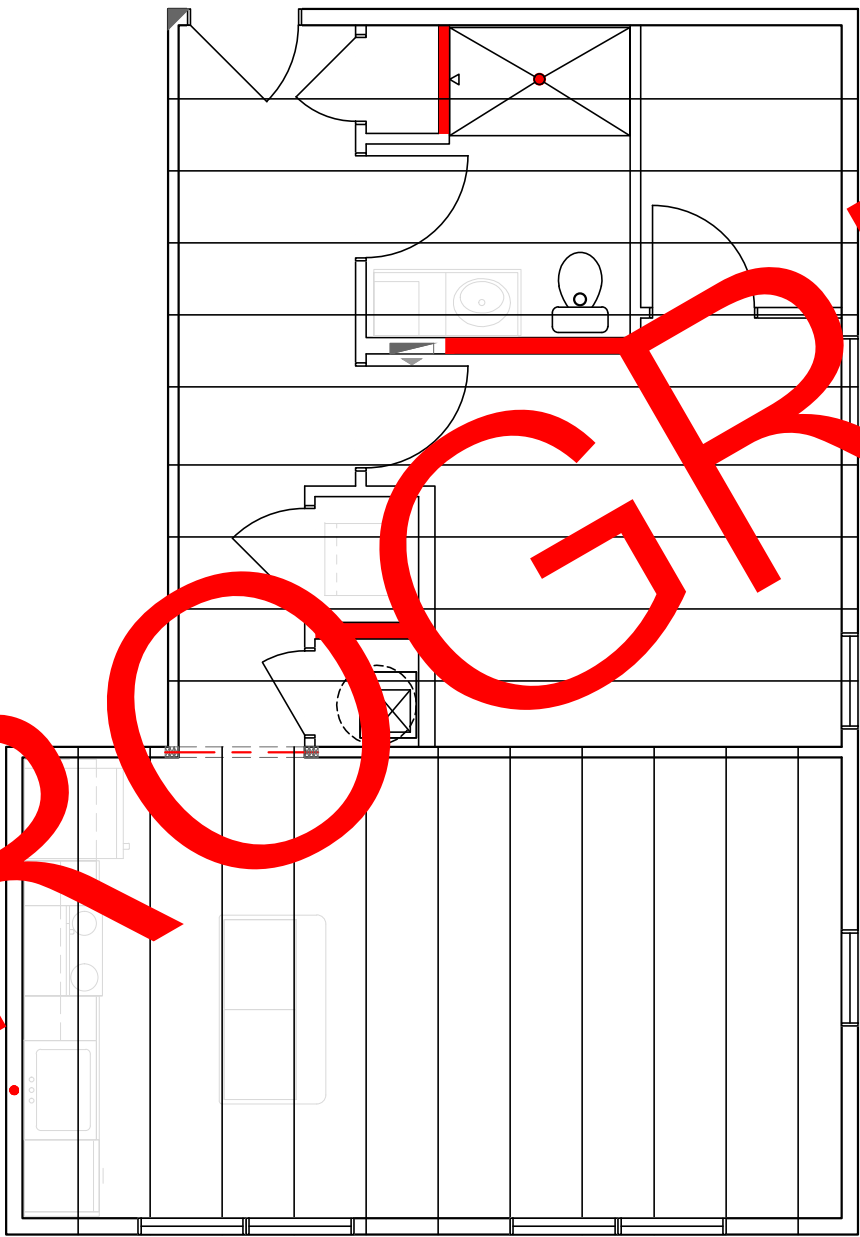

UNIT A5 FLOOR FRAMING  
Scale: 3/16" = 1'-0"


- == HIGH/LOW CLOSET RODS (T/SHELVES @ 42" / 84" AFF)
- SINGLE CLOSET ROD (T/SHELF @ 72" AFF). AT BEDROOM CLOSETS, INCLUDE ANGLED SHOE SHELF BELOW (14" AFF REAR, 7" AFF FRONT)
- \*\*\*\*\* INDICATES CROWN MOULDING
- ⎓ INDICATES ELECTRIC PANEL (SEE MEP)

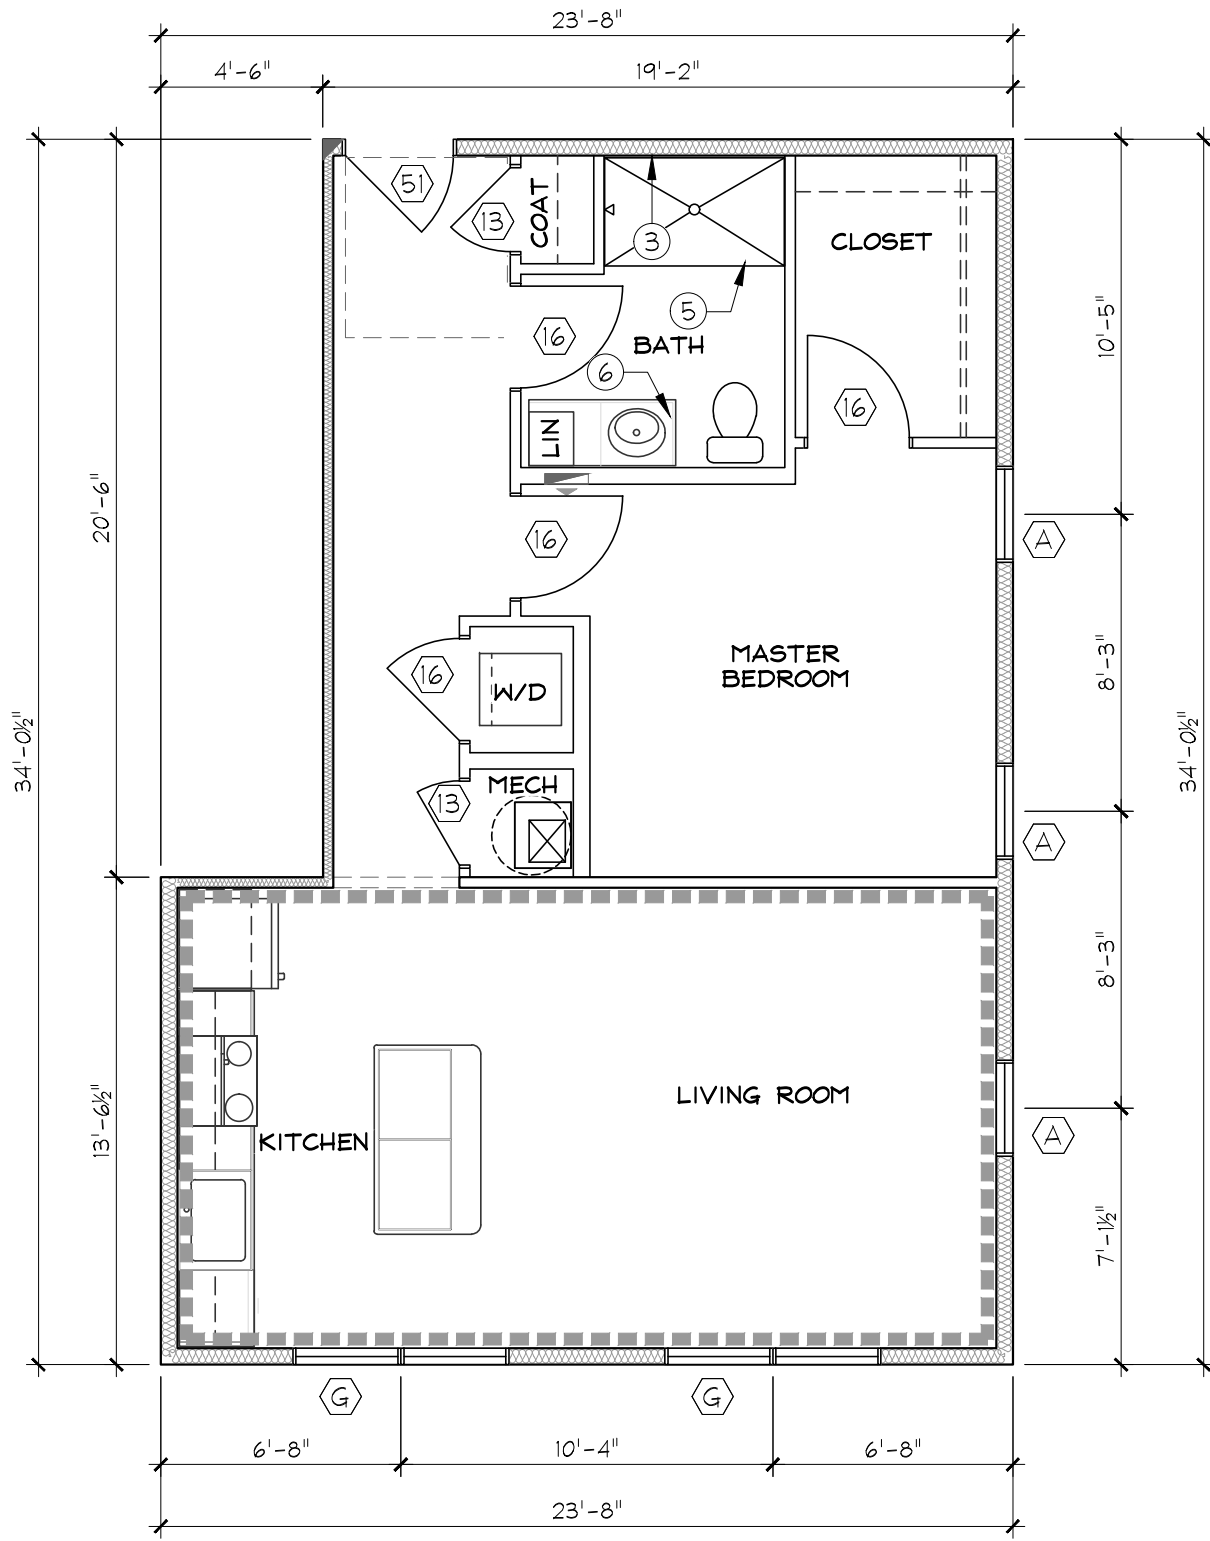

UNIT A5 FLOOR PLAN - HEATED SF (713) - QTY (3)  
Scale: 3/16" = 1'-0"

- UNIT WALL FRAMING NOTES:**
- UNSHADED WALLS ARE NON-BEARING (SPF STUD GRADE @ 16 OC).
  - INTERIOR NON-BEARING WALLS ARE 2x4 (UNO).
  - SEE FLOOR AND ROOF FRAMING PLANS FOR BEAM INFORMATION.
  - SEE SHEAR WALL PLANS FOR EXTERIOR SHEATHING TYPE & FASTENING.

- 615 A1A INDICATES BEARING WALL STUD SPECIFICATIONS. SEE G5.1 FOR SCHEDULE. COLOR SHOWN IN WALL INDICATES SPECS FOR THE LOWEST LEVEL ON WHICH THE UNIT OCCURS.
- INDICATES UNIT TYPE DOES NOT OCCUR AT LEVEL SHOWN.
- NB INDICATES WALL IS NON-BEARING AT LEVEL SHOWN.

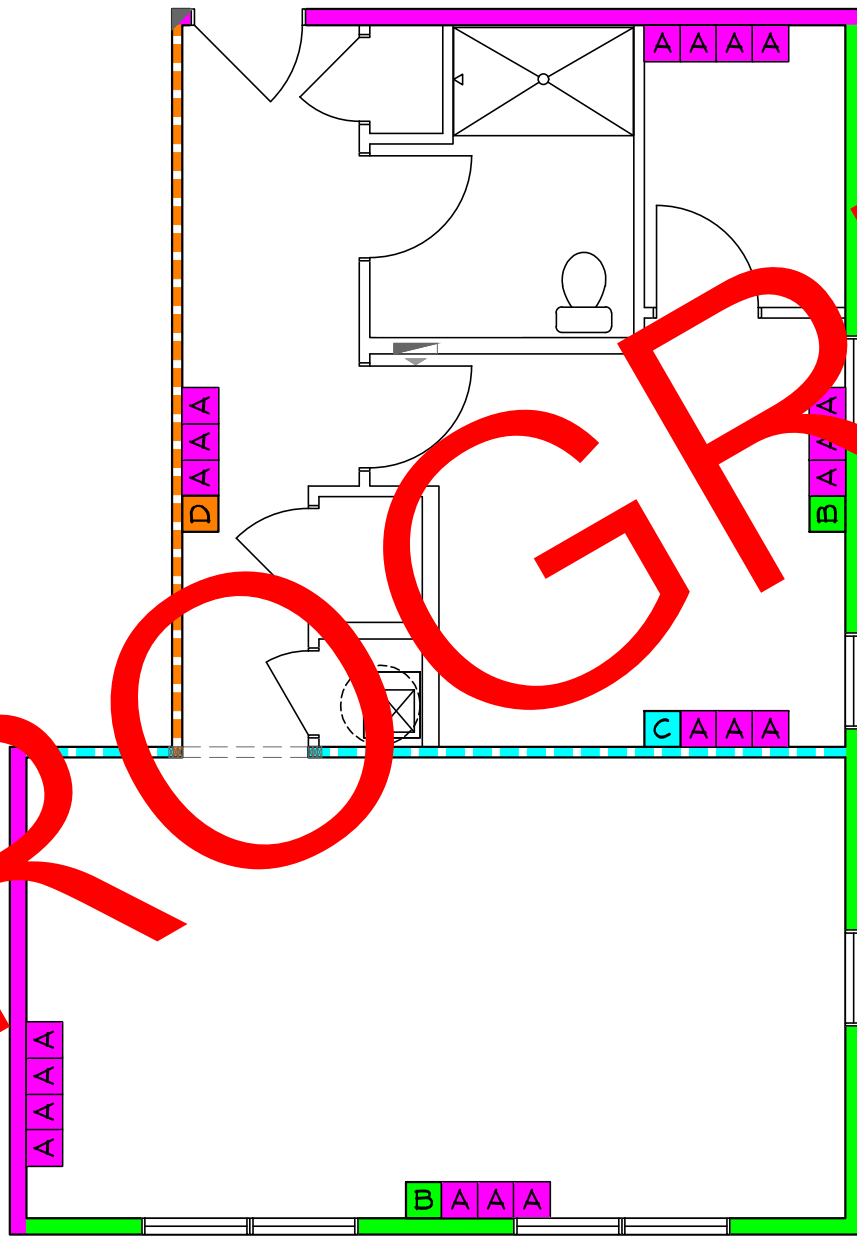

COMPLETE WALL FRAMING  
DIMENSIONS TO BE PROVIDED IN  
CONSTRUCTION RELEASE PLANS

UNIT A5 WALL FRAMING  
Scale: 3/16" = 1'-0"

- (#) INDICATES DOOR OR WINDOW TYPE. SEE G5.1 & G5.2 FOR SCHEDULE. WHERE MULTIPLE TYPES ARE SHOWN, SEE FRAMING ELEVATIONS.
- ▨▨▨▨▨ INDICATES R13 BATTS @ 2x4 INTERIOR WALLS, R19 BATTS @ 2x6 EXTERIOR WALLS AND CORRIDOR WALLS.

UNIT PLAN NOTES:

1. ALL DIMENSIONS ARE TO FACE OF STUD OR CENTERLINE OF TRUSS (UNO).
2. DOORS & WINDOWS ARE DIMENSIONED TO CENTER, CENTERED BETWEEN ADJACENT WALLS OR 3" AWAY FROM NEAREST WALL.
3. SEE BUILDING FLOOR PLANS FOR OVERALL BUILDING LAYOUT AND SPECIFICATIONS.
4. ▣ INDICATES REFERENCE POINT FOR STARTING DIMENSIONAL LAYOUT & UNIT ORIENTATION.
5. ALL UNITS ARE 'TYPE B' (UNO). SEE BUILDING PLANS FOR UNITS COMPLYING WITH TYPE 'A' AND 'IAC' REQUIREMENTS. SEE G4.1- G4.2 FOR REQUIRED CLEARANCES AT FIXTURES, APPLIANCES, KITCHEN ISLANDS, ETC.
6. UNIT FINISHES TO BE SELECTED BY OWNER.
7. SEE U4.1-U4.4 FOR INTERIOR ELEVATIONS AT KITCHENS AND BATHS.
8. SEE G0.1 FOR GENERAL NOTES.
9. FLOOR ASSEMBLIES & FINISHES:
  - 9.1. ▨ INDICATES CARPET & PADDING OVER 1" GYP-CRETE OVER 3/4" SUBFLOOR OVER OPEN-WEB FLOOR TRUSSES WITH INSULATION, RESILIENT CHANNEL AND 5/8" GYPSUM CEILING (UNO). (UL #L521, STC 56, IIC 69).
  - 9.2. ▨ INDICATES VINYL PLANK OVER 3/4" GYP-CRETE OVER 3/4" SOUND MAT OVER 3/4" SUBFLOOR OVER OPEN-WEB FLOOR TRUSSES WITH INSULATION, RESILIENT CHANNEL AND 5/8" GYPSUM CEILING. (UL #L521, STC 56, IIC 56).
  - 9.3. ▨ INDICATES CERAMIC TILE OVER 3/4" GYP-CRETE OVER 3/4" SOUND MAT OVER 3/4" SUBFLOOR OVER OPEN-WEB FLOOR TRUSSES WITH INSULATION, RESILIENT CHANNEL AND 5/8" GYPSUM CEILING. (UL #L521, STC 56, IIC 54).

KEY NOTES:

- ① 18" DEEP OPEN WEB, METAL PLATE CONNECTED WOOD FLOOR TRUSSES SPACED @ 24" OC (UNO)
- ② 2x6 KNEE WALL
- ③ REQUIRES PRE-INSTALLED 5/8" TYPE 'X' GYP AT WALL AND/OR CEILING PRIOR TO COMPLETION OF FRAMING OR INSTALL OF FIXTURE TO MAINTAIN FIRE-RATING
- ④ 36" x 60" TUB w/ SURROUND (UNO)
- ⑤ 36" x 60" SHOWER BASE w/ SURROUND (UNO)
- ⑥ VANITY CABINET & COUNTERTOP (SEE U4.4)
- ⑦ 42" GUARD RAIL w/ BALUSTERS @ 4" OC (MAX) (SEE BLDG FLOOR PLANS & ELEVATIONS FOR UNITS W/OUT RAILING)
- ⑧ 2x10's #2 SYP PT @ 16" OC

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MO CERTIFICATE OF AUTHORITY #2013004334 (ARCHITECTURE)

**CHROMA II**  
**MIXED-USE DEVELOPMENT**  
(CONCEPT 2.3)


ST. LOUIS, MO

NO	REVISIONS	DATE

DRAWING TITLE  
UNIT PLANS: A5


PROJECT # 850	DRAWING NUMBER U1.7
DATE 02/22/19	DESIGN DEVELOPMENT

- LIGHT FIXTURE PLACEMENT:**
- PLACE LIGHTS AS SHOWN. ADJUST FOR STRUCTURE AS NEEDED WHILE MAINTAINING DESIGN INTENT.
  - SEE INTERIOR ELEVATIONS (U4 SHEETS) FOR VANITY DIMENSIONS AND CENTER FIXTURES ACCORDINGLY.

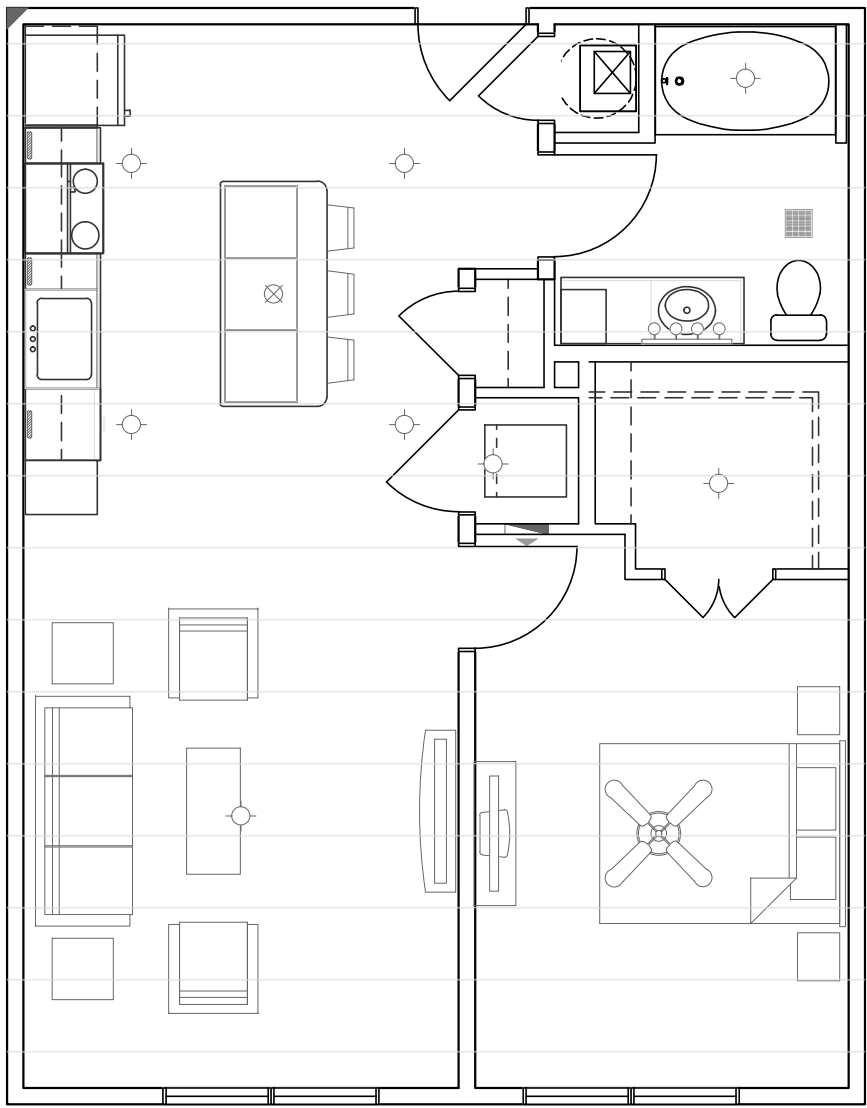

UNIT A6 LIGHT FIXTURE & FURNITURE PLACEMENT PLAN  
Scale: 3/16" = 1'-0"

- == HIGH/LOW CLOSET RODS (T/SHELVES @ 42" / 84" AFF)
- SINGLE CLOSET ROD (T/SHELF @ 72" AFF). AT BEDROOM CLOSETS, INCLUDE ANGLED SHOE SHELF BELOW (14" AFF REAR, 7" AFF FRONT)
- \*\*\*\*\* INDICATES CROWN MOULDING
- ⎓ INDICATES ELECTRIC PANEL (SEE MEP)

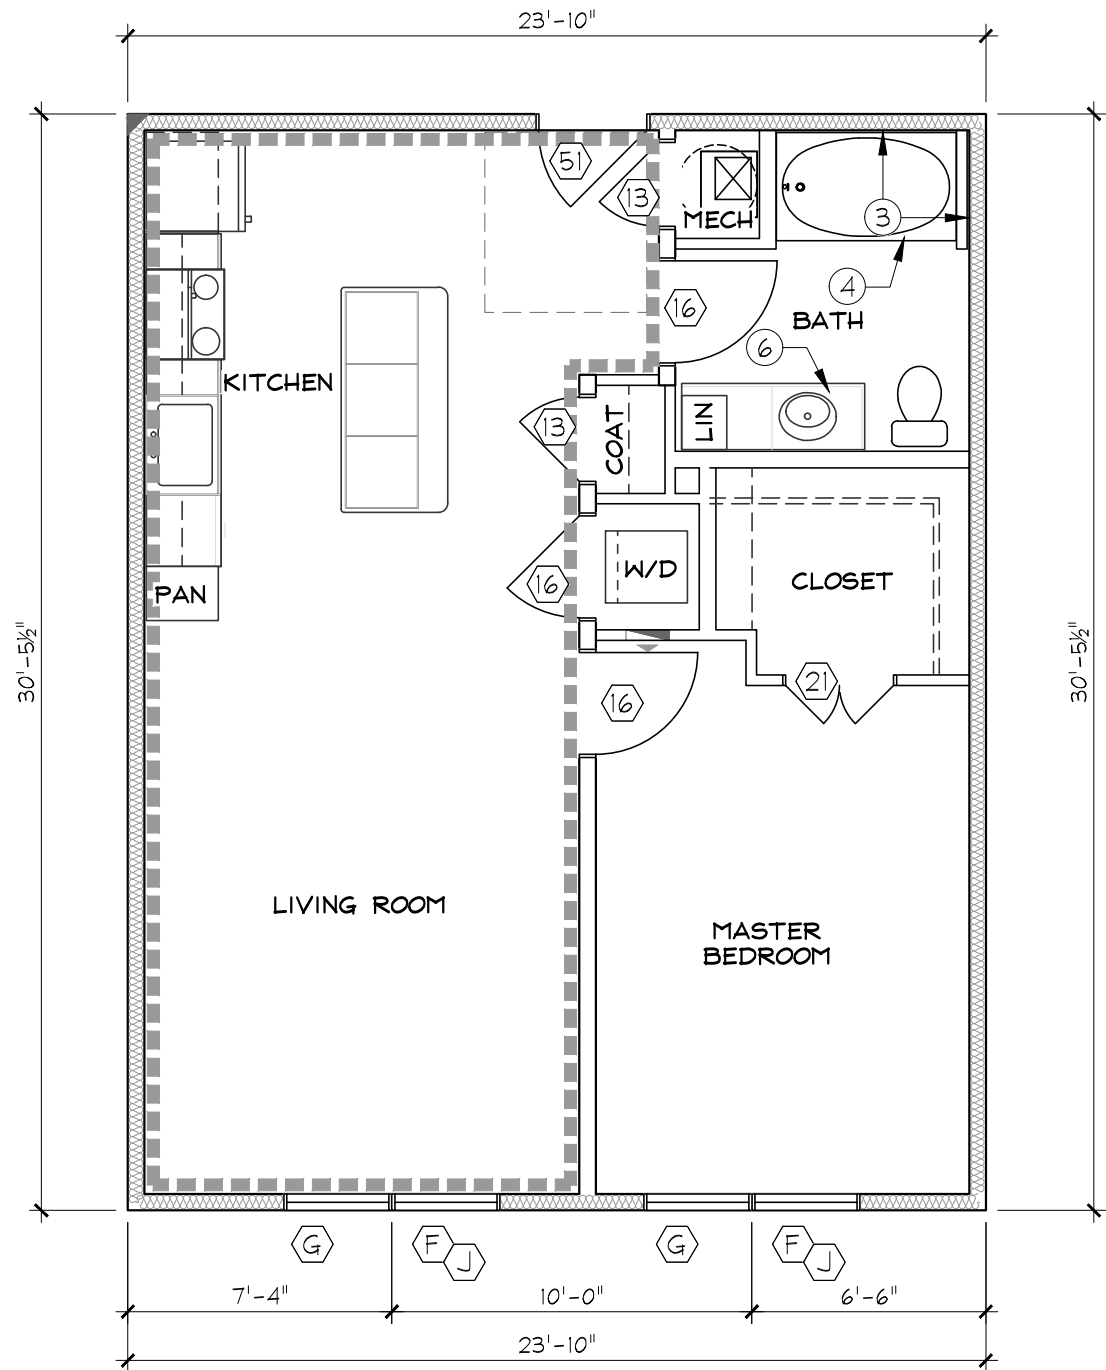

UNIT A6 FLOOR PLAN - HEATED SF (726) - QTY (4)  
Scale: 3/16" = 1'-0"


- # INDICATES DOOR OR WINDOW TYPE. SEE G5.1 & G5.2 FOR SCHEDULE. WHERE MULTIPLE TYPES ARE SHOWN, SEE FRAMING ELEVATIONS.
- INDICATES R13 BATTS @ 2x4 INTERIOR WALLS, R19 BATTS @ 2x6 EXTERIOR WALLS AND CORRIDOR WALLS.

- UNIT PLAN NOTES:
1. ALL DIMENSIONS ARE TO FACE OF STUD OR CENTERLINE OF TRUSS (UNO).
  2. DOORS & WINDOWS ARE DIMENSIONED TO CENTER, CENTERED BETWEEN ADJACENT WALLS OR 3" AWAY FROM NEAREST WALL.
  3. SEE BUILDING FLOOR PLANS FOR OVERALL BUILDING LAYOUT AND SPECIFICATIONS.
  4. INDICATES REFERENCE POINT FOR STARTING DIMENSIONAL LAYOUT & UNIT ORIENTATION.
  5. ALL UNITS ARE 'TYPE B' (UNO). SEE BUILDING PLANS FOR UNITS COMPLYING WITH 'TYPE A' AND 'IAC' REQUIREMENTS. SEE G4.1- G4.2 FOR REQUIRED CLEARANCES AT FIXTURES, APPLIANCES, KITCHEN ISLANDS, ETC.
  6. UNIT FINISHES TO BE SELECTED BY OWNER.
  7. SEE U4.1-U4.4 FOR INTERIOR ELEVATIONS AT KITCHENS AND BATHS.
  8. SEE G0.1 FOR GENERAL NOTES.
  9. FLOOR ASSEMBLIES & FINISHES:
    - 9.1. INDICATES CARPET & PADDING OVER 1" GYP-CRETE OVER 3/4" SUBFLOOR OVER OPEN-WEB FLOOR TRUSSES WITH INSULATION, RESILIENT CHANNEL AND 5/8" GYPSUM CEILING (UNO). (UL #L521, STC 56, IIC 69).
    - 9.2. INDICATES VINYL PLANK OVER 3/4" GYP-CRETE OVER 1/2" SOUND MAT OVER 1/2" SUBFLOOR OVER OPEN-WEB FLOOR TRUSSES WITH INSULATION, RESILIENT CHANNEL AND 5/8" GYPSUM CEILING. (UL #L521, STC 56, IIC 56).
    - 9.3. INDICATES CERAMIC TILE OVER 3/4" GYP-CRETE OVER 1/2" SOUND MAT OVER 1/2" SUBFLOOR OVER OPEN-WEB FLOOR TRUSSES WITH INSULATION, RESILIENT CHANNEL AND 5/8" GYPSUM CEILING. (UL #L521, STC 56, IIC 54).

- KEY NOTES:
- ① 18" DEEP OPEN WEB, METAL PLATE CONNECTED WOOD FLOOR TRUSSES SPACED @ 24" OC (UNO)
  - ② 2x6 KNEE WALL
  - ③ REQUIRES PRE-INSTALLED 5/8" TYPE 'X' GYP AT WALL AND/OR CEILING PRIOR TO COMPLETION OF FRAMING OR INSTALL OF FIXTURE TO MAINTAIN FIRE-RATING
  - ④ 36" x 60" TUB w/ SURROUND (UNO)
  - ⑤ 36" x 60" SHOWER BASE w/ SURROUND (UNO)
  - ⑥ VANITY CABINET & COUNTERTOP (SEE U4.4)
  - ⑦ 42" GUARD RAIL w/ BALUSTERS @ 4" OC (MAX) (SEE BLDG FLOOR PLANS & ELEVATIONS FOR UNITS W/OUT RAILING)
  - ⑧ 2x10's #2 SYP PT @ 16" OC

- UNIT FLOOR FRAMING NOTES:**
- PLAN SHOWS UNIT FLOOR SYSTEM AND WALLS BELOW.
  - VERIFY PLUMBING DRAIN LOCATIONS WITH CONTRACTOR AND ADJUST TRUSS SPACING AS REQUIRED.
  - SEE BUILDING FRAMING PLANS FOR CORRIDOR FRAMING & ADDITIONAL FRAMING DETAIL CALLOUTS.


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- INDICATES PLUMBING VENT (2" MAX I.D.), OFFSET FROM LIGHT FIXTURE 6" MINIMUM.
- INDICATES INTERIOR LOAD BEARING WALL (LEVELS 1-3). ALL UNIT PERIMETER WALLS ARE BEARING (UNO).
- ◆ INDICATES BEAM FOR TRUSS BEARING. SEE G5.1 FOR BEAM SCHEDULE.

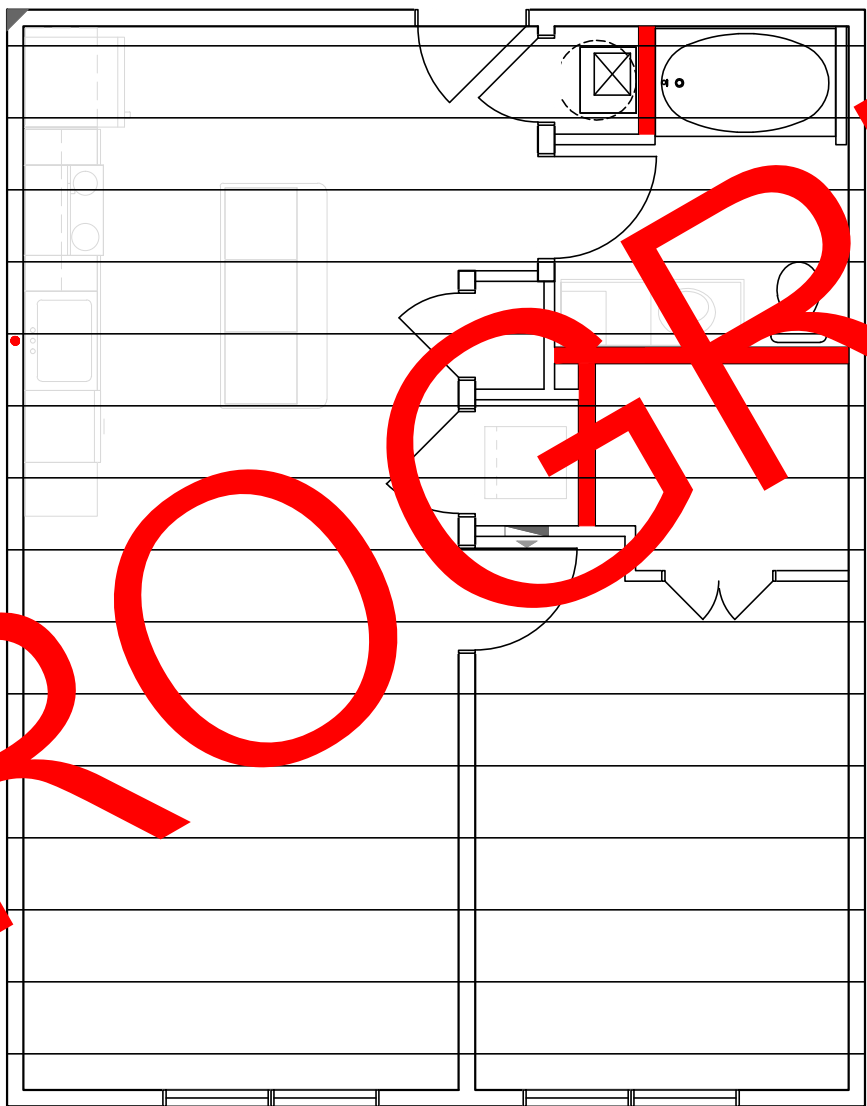

UNIT A6 FLOOR FRAMING  
Scale: 3/16" = 1'-0"

- UNIT WALL FRAMING NOTES:**
- UNSHADED WALLS ARE NON-BEARING (SPF STUD GRADE @ 16 OC).
  - INTERIOR NON-BEARING WALLS ARE 2x4 (UNO).
  - SEE FLOOR AND ROOF FRAMING PLANS FOR BEAM INFORMATION.
  - SEE SHEAR WALL PLANS FOR EXTERIOR SHEATHING TYPE & FASTENING.

- INDICATES BEARING WALL STUD SPECIFICATIONS. SEE G5.1 FOR SCHEDULE. COLOR SHOWN IN WALL INDICATES SPECS FOR THE LOWEST LEVEL ON WHICH THE UNIT OCCURS.
- INDICATES UNIT TYPE DOES NOT OCCUR AT LEVEL SHOWN.
- INDICATES WALL IS NON-BEARING AT LEVEL SHOWN.

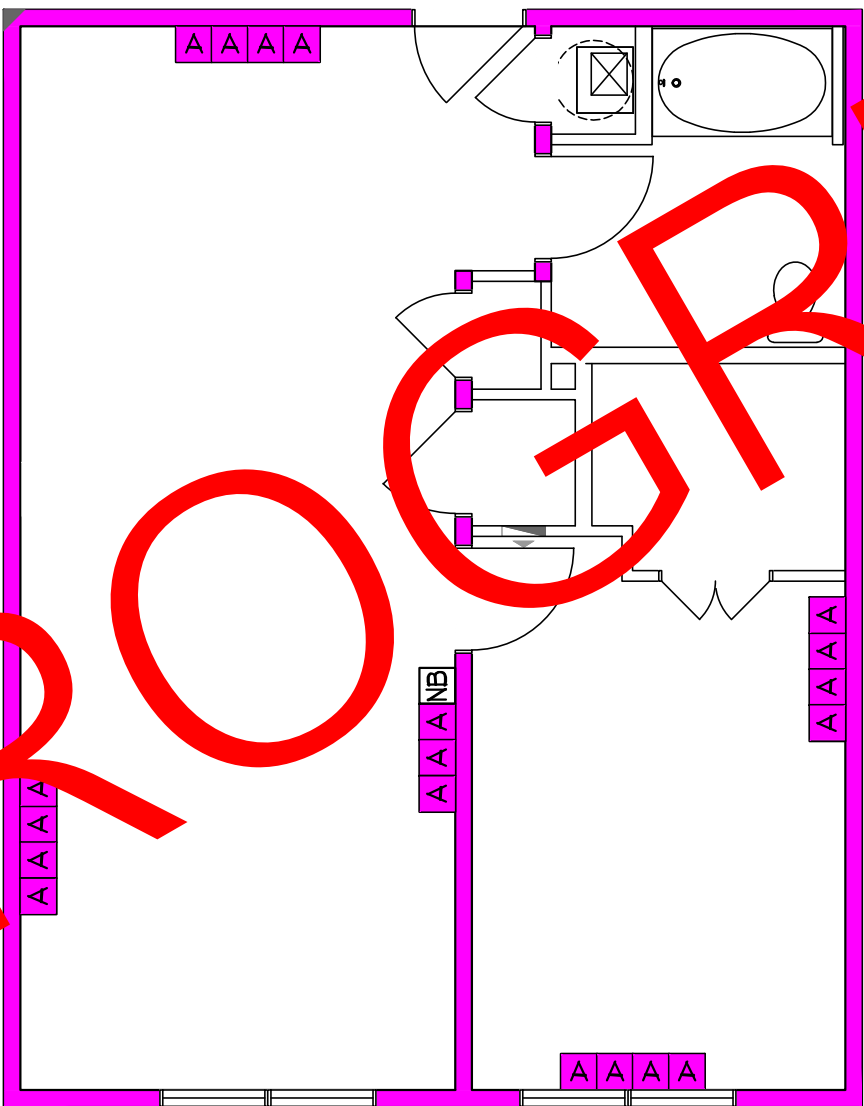

COMPLETE WALL FRAMING DIMENSIONS TO BE PROVIDED IN CONSTRUCTION RELEASE PLANS

UNIT A6 WALL FRAMING  
Scale: 3/16" = 1'-0"

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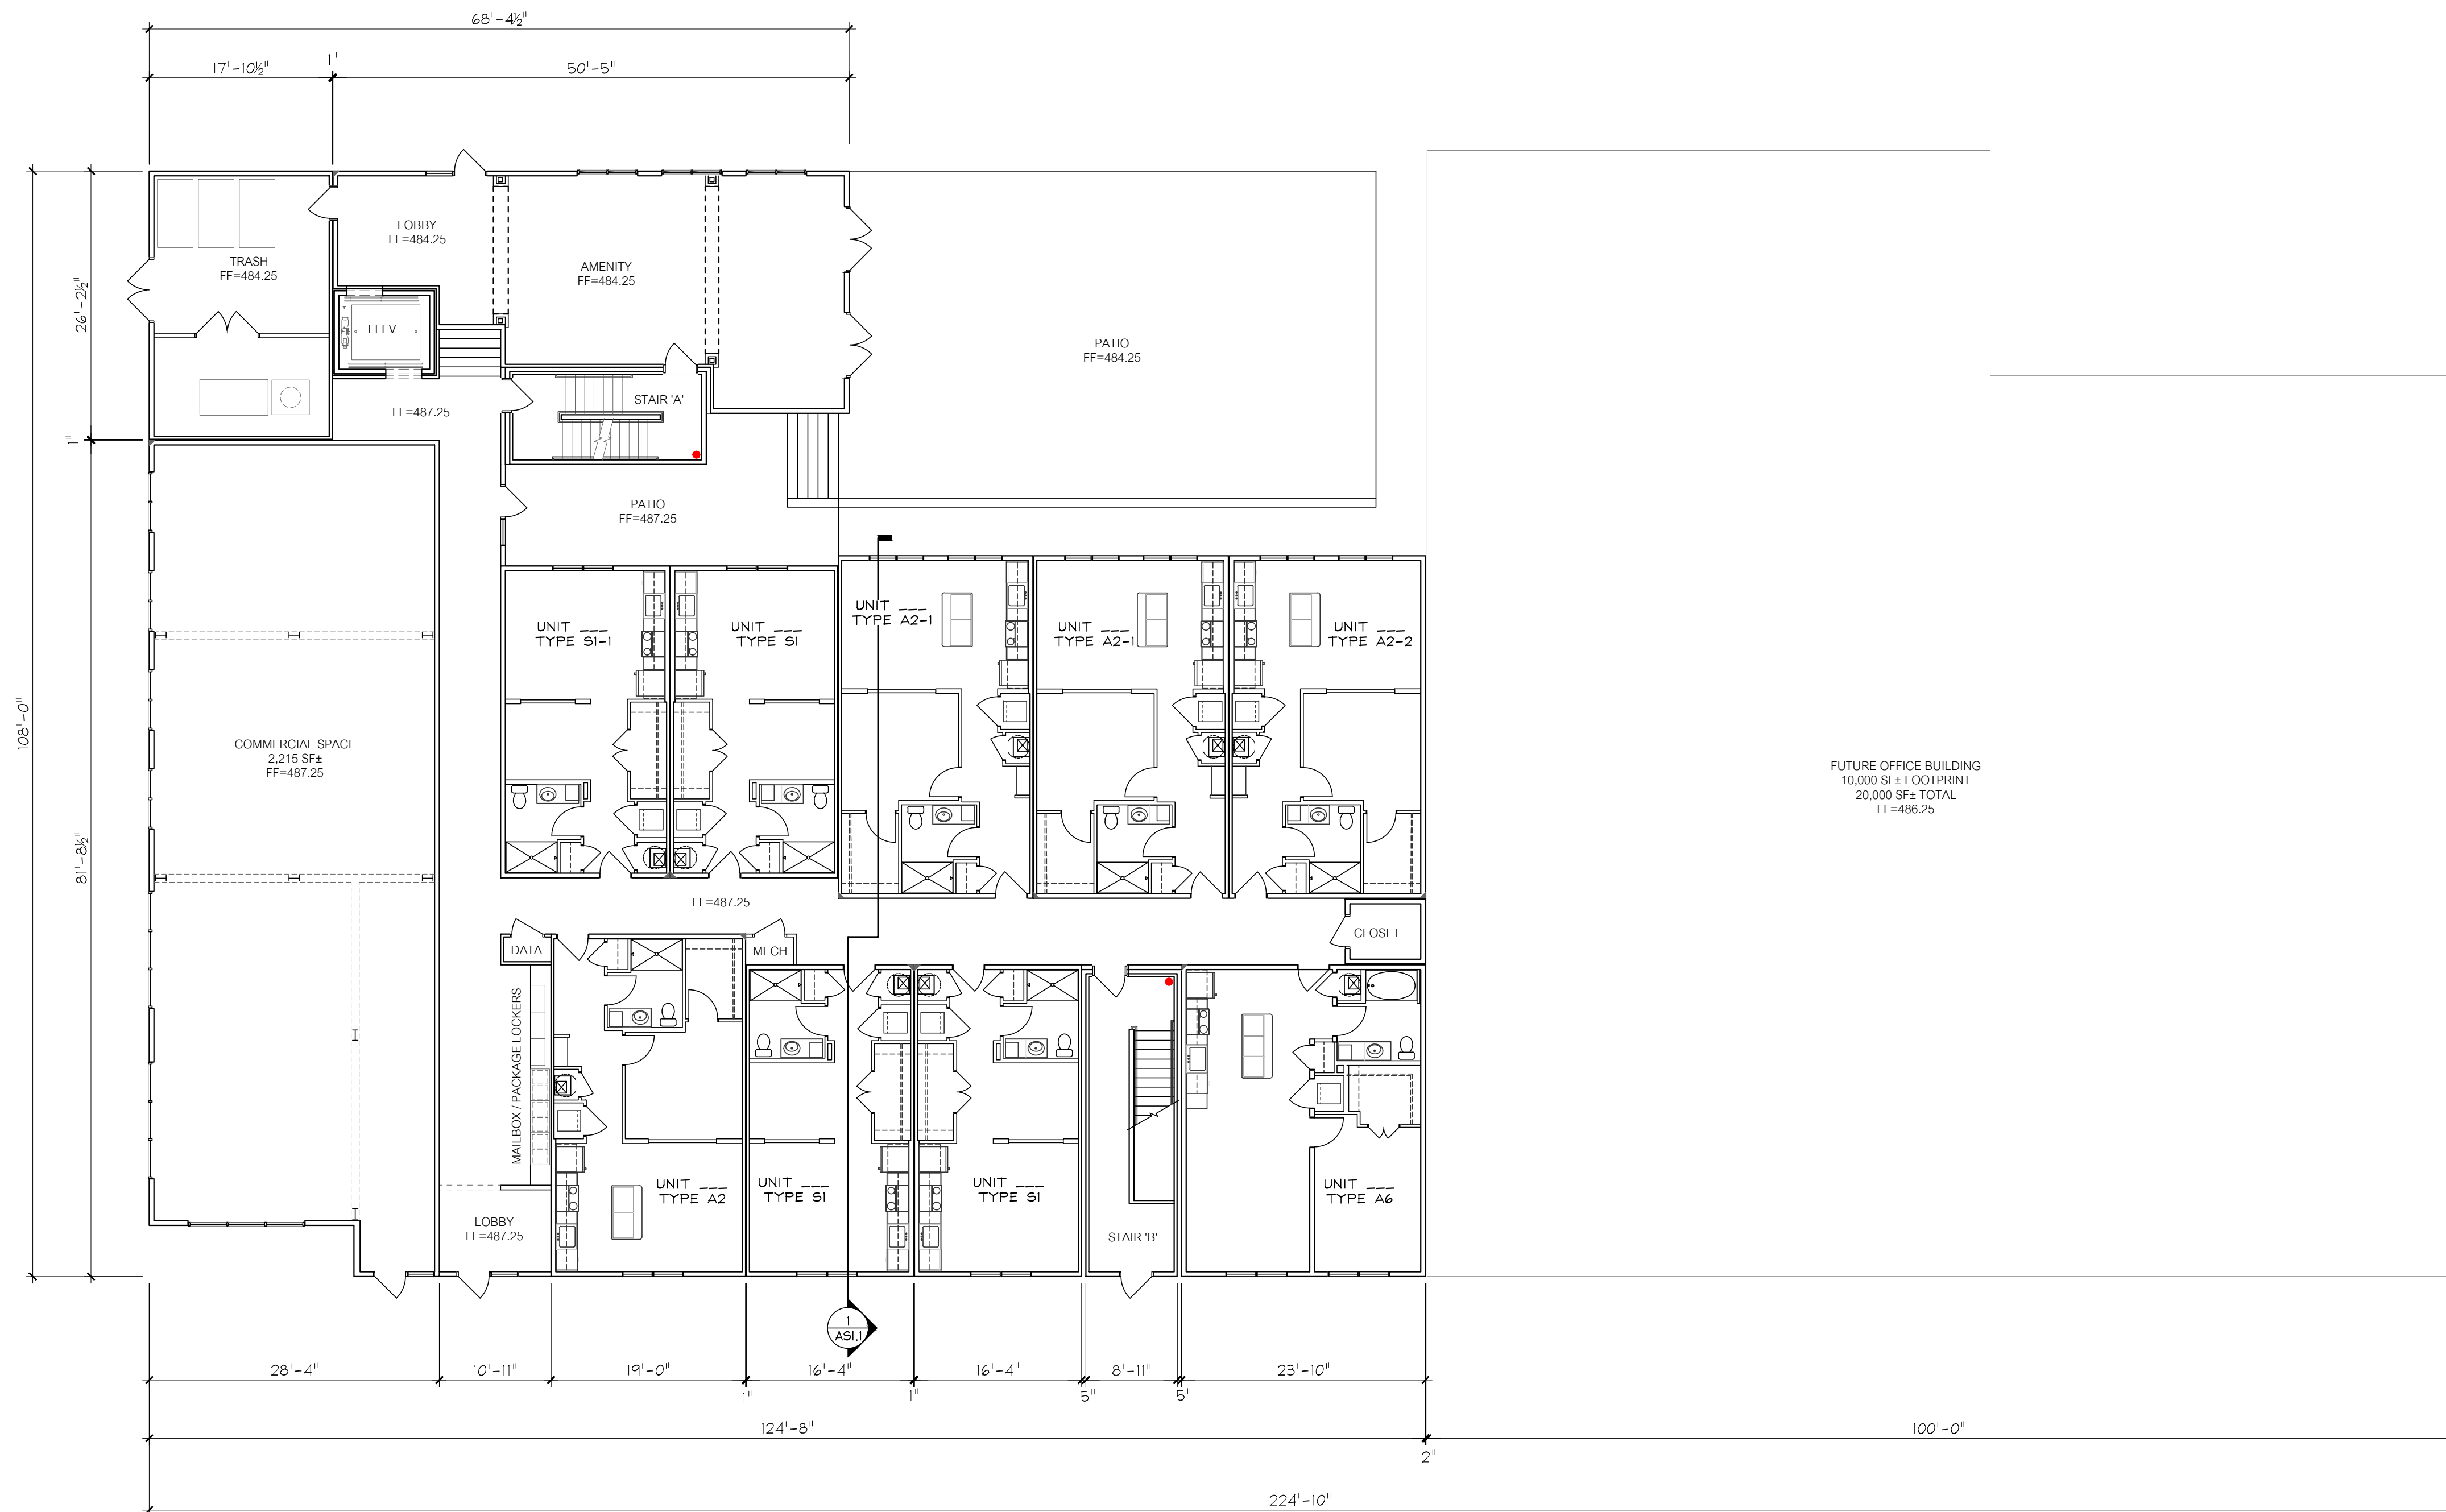
**CHROMA II**  
**MIXED-USE DEVELOPMENT**  
(CONCEPT 2.3)

ST. LOUIS, MO


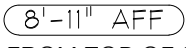

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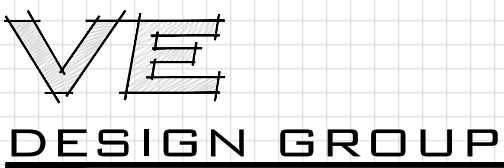
DRAWING TITLE  
UNIT PLANS: A6

PROJECT # 850	DRAWING NUMBER U1.8
DATE 02/22/19	DESIGN DEVELOPMENT



BUILDING FLOOR PLAN NOTES:

1. ALL DIMENSIONS ARE TO FACE OF STUD (UNO).
2. SEE ENLARGED UNIT & STAIR PLANS FOR DETAILED INFORMATION NOT SHOWN.
3.  INDICATES REFERENCE POINT FOR UNIT ORIENTATION & DIMENSIONAL LAYOUT.
4. SEE BUILDING ELEVATIONS FOR EXTERIOR FINISH MATERIALS.
5. SEE FRAMING ELEVATIONS & SECTIONS FOR WALL HEIGHTS, FLOOR-TO-FLOOR HEIGHTS, PARAPET HEIGHTS, ETC.
6. FINISH SPECIFICATIONS ARE BY OWNER / GC.
7. SEE ENLARGED UNIT PLANS FOR FLOOR FINISH & ASSEMBLIES INSIDE UNITS.
8.  INDICATES CEILING HEIGHT FROM TOP OF SLAB OR GYP-CRETE TO BOTTOM OF GYPSUM CEILING.
9. SEE G SHEETS (FIRE PROTECTION) FOR FIRE RATED WALLS AND OPENINGS.
10.  INDICATES CLASS I STANDPIPE INSTALLED PER IBC SECTION 905 & NFPA 14. SEE SPRINKLER DESIGN DRAWINGS FOR MORE INFORMATION.
11. COMMON WALLS NOT SHOWN IN ENLARGED PLANS ARE 2x4 (UNO). STUDS TO BE SPACED @ 16" OC (SPF STUD). PLATES TO BE #2 (TREATED @ CONCRETE).
12. FLOORING OVER CONCRETE OR 1" GYP-CRETE IN COMMON AREAS TO BE SPECIFIED BY OWNER / GC.
13. SEE G0.1 FOR GENERAL NOTES.



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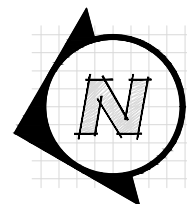
**CHROMA II  
MIXED-USE DEVELOPMENT  
(CONCEPT 2.3)**

ST. LOUIS, MO


NO	REVISIONS	DATE

DRAWING TITLE  
**FLOOR PLAN - LEVEL 1**

PROJECT # <b>850</b>	DRAWING NUMBER <b>A1.1</b>
DATE <b>02/22/19</b>	DESIGN DEVELOPMENT



**FLOOR PLAN - LEVEL 1**  
Scale: 3/32" = 1'-0"

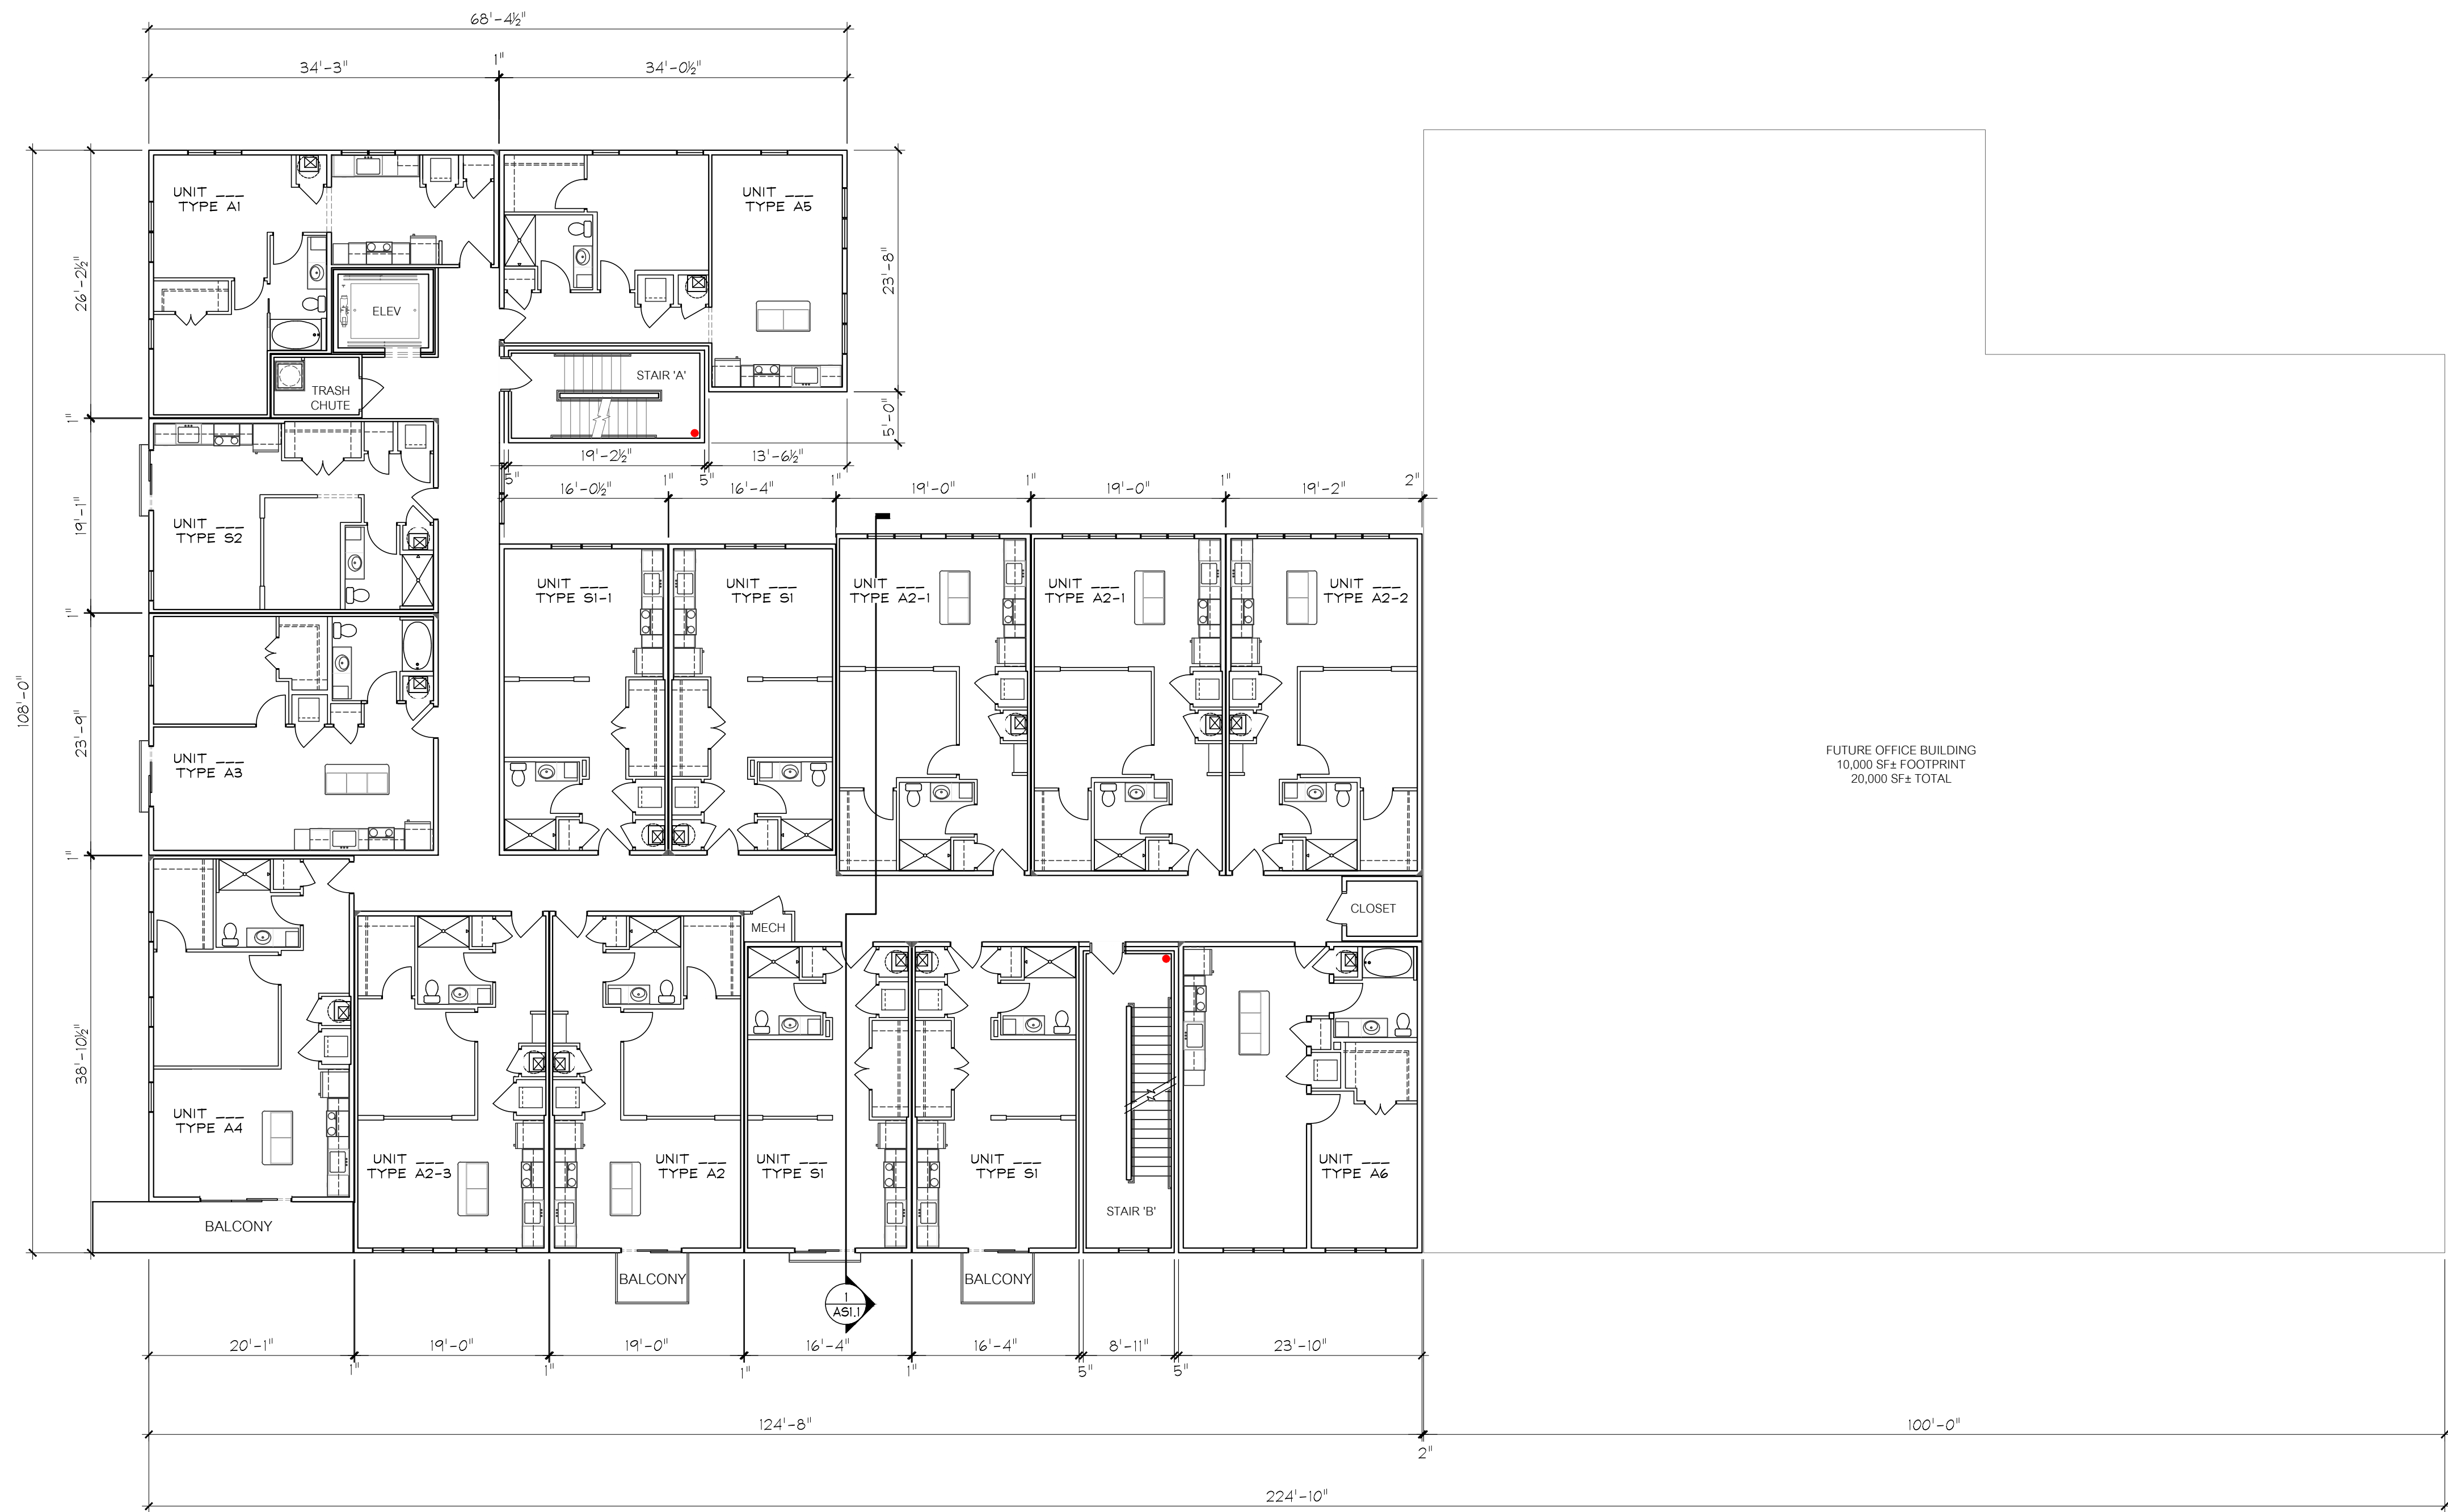

FUTURE OFFICE BUILDING  
10,000 SF± FOOTPRINT  
20,000 SF± TOTAL

- BUILDING FLOOR PLAN NOTES:
- ALL DIMENSIONS ARE TO FACE OF STUD (UNO).
  - SEE ENLARGED UNIT & STAIR PLANS FOR DETAILED INFORMATION NOT SHOWN.
  - INDICATES REFERENCE POINT FOR UNIT ORIENTATION & DIMENSIONAL LAYOUT.
  - SEE BUILDING ELEVATIONS FOR EXTERIOR FINISH MATERIALS.
  - SEE FRAMING ELEVATIONS & SECTIONS FOR WALL HEIGHTS, FLOOR-TO-FLOOR HEIGHTS, PARAPET HEIGHTS, ETC.
  - FINISH SPECIFICATIONS ARE BY OWNER / GC.
  - SEE ENLARGED UNIT PLANS FOR FLOOR FINISH & ASSEMBLIES INSIDE UNITS.
  - 8'-11" AFF INDICATES CEILING HEIGHT FROM TOP OF SLAB OR GYP-CRETE TO BOTTOM OF GYPSUM CEILING.
  - SEE G SHEETS (FIRE PROTECTION) FOR FIRE RATED WALLS AND OPENINGS.
  - INDICATES CLASS I STANDPIPE INSTALLED PER IBC SECTION 905 & NFPA 14. SEE SPRINKLER DESIGN DRAWINGS FOR MORE INFORMATION.
  - COMMON WALLS NOT SHOWN IN ENLARGED PLANS ARE 2x4 (UNO). STUDS TO BE SPACED @ 16" OC (SPF STUD). PLATES TO BE #2 (TREATED @ CONCRETE).
  - FLOORING OVER CONCRETE OR 1" GYP-CRETE IN COMMON AREAS TO BE SPECIFIED BY OWNER / GC.
  - SEE G0.1 FOR GENERAL NOTES.

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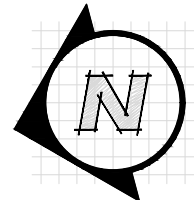
**CHROMA II**  
**MIXED-USE DEVELOPMENT**  
(CONCEPT 2.3)

ST. LOUIS, MO


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DRAWING TITLE  
**FLOOR PLAN - LEVEL 2**


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DATE <b>02/22/19</b>	DESIGN DEVELOPMENT




**FLOOR PLAN - LEVEL 2**  
Scale: 3/32" = 1'-0"

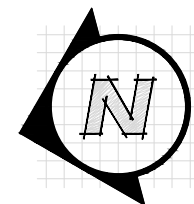

FLOOR PLAN - LEVEL 3  
Scale: 3/32" = 1'-0"

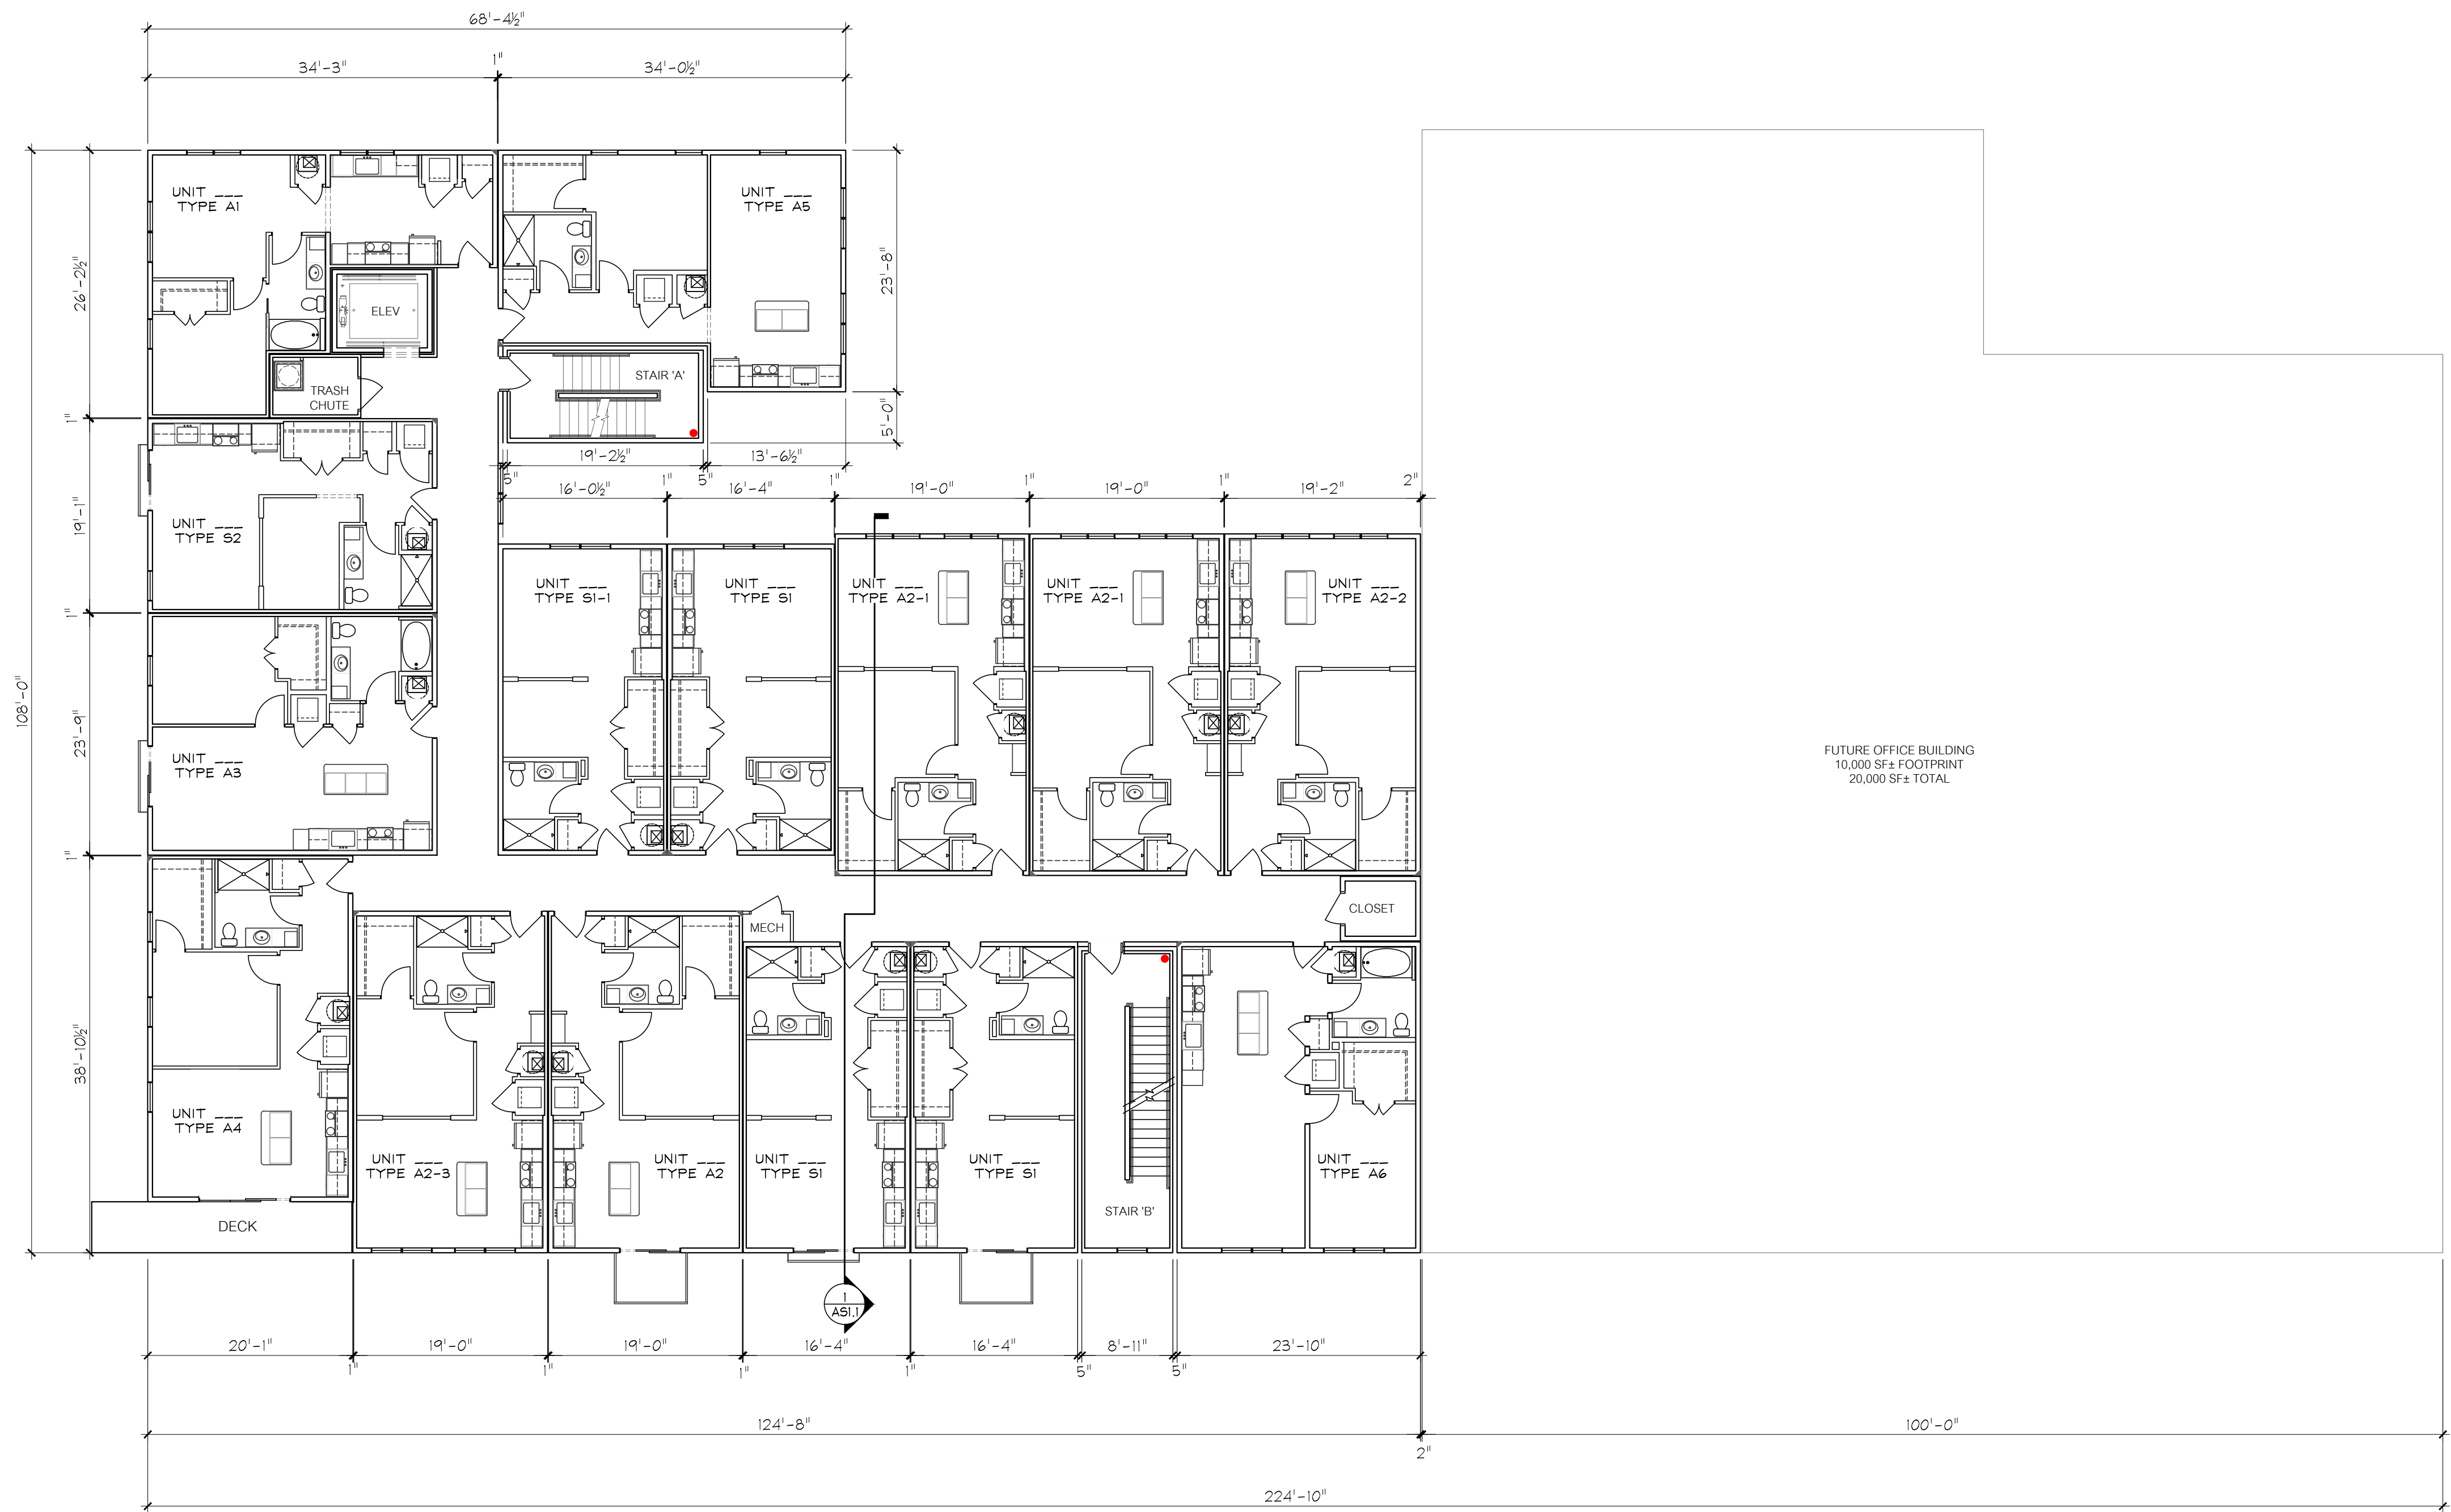

- BUILDING FLOOR PLAN NOTES:
1. ALL DIMENSIONS ARE TO FACE OF STUD (UNO).
  2. SEE ENLARGED UNIT & STAIR PLANS FOR DETAILED INFORMATION NOT SHOWN.
  3. ■ INDICATES REFERENCE POINT FOR UNIT ORIENTATION & DIMENSIONAL LAYOUT.
  4. SEE BUILDING ELEVATIONS FOR EXTERIOR FINISH MATERIALS.
  5. SEE FRAMING ELEVATIONS & SECTIONS FOR WALL HEIGHTS, FLOOR-TO-FLOOR HEIGHTS, PARAPET HEIGHTS, ETC.
  6. FINISH SPECIFICATIONS ARE BY OWNER / GC.
  7. SEE ENLARGED UNIT PLANS FOR FLOOR FINISH & ASSEMBLIES INSIDE UNITS.
  8. (8'-11" AFF) INDICATES CEILING HEIGHT FROM TOP OF SLAB OR GYP-CRETE TO BOTTOM OF GYPSUM CEILING.
  9. SEE G SHEETS (FIRE PROTECTION) FOR FIRE RATED WALLS AND OPENINGS.
  10. ■ INDICATES CLASS I STANDPIPE INSTALLED PER IBC SECTION 905 & NFPA 14. SEE SPRINKLER DESIGN DRAWINGS FOR MORE INFORMATION.
  11. COMMON WALLS NOT SHOWN IN ENLARGED PLANS ARE 2x4 (UNO). STUDS TO BE SPACED @ 16" OC (SPF STUD). PLATES TO BE #2 (TREATED @ CONCRETE).
  12. FLOORING OVER CONCRETE OR 1" GYP-CRETE IN COMMON AREAS TO BE SPECIFIED BY OWNER / GC.
  13. SEE G0.1 FOR GENERAL NOTES.

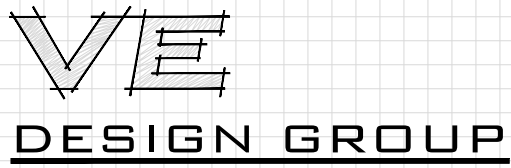

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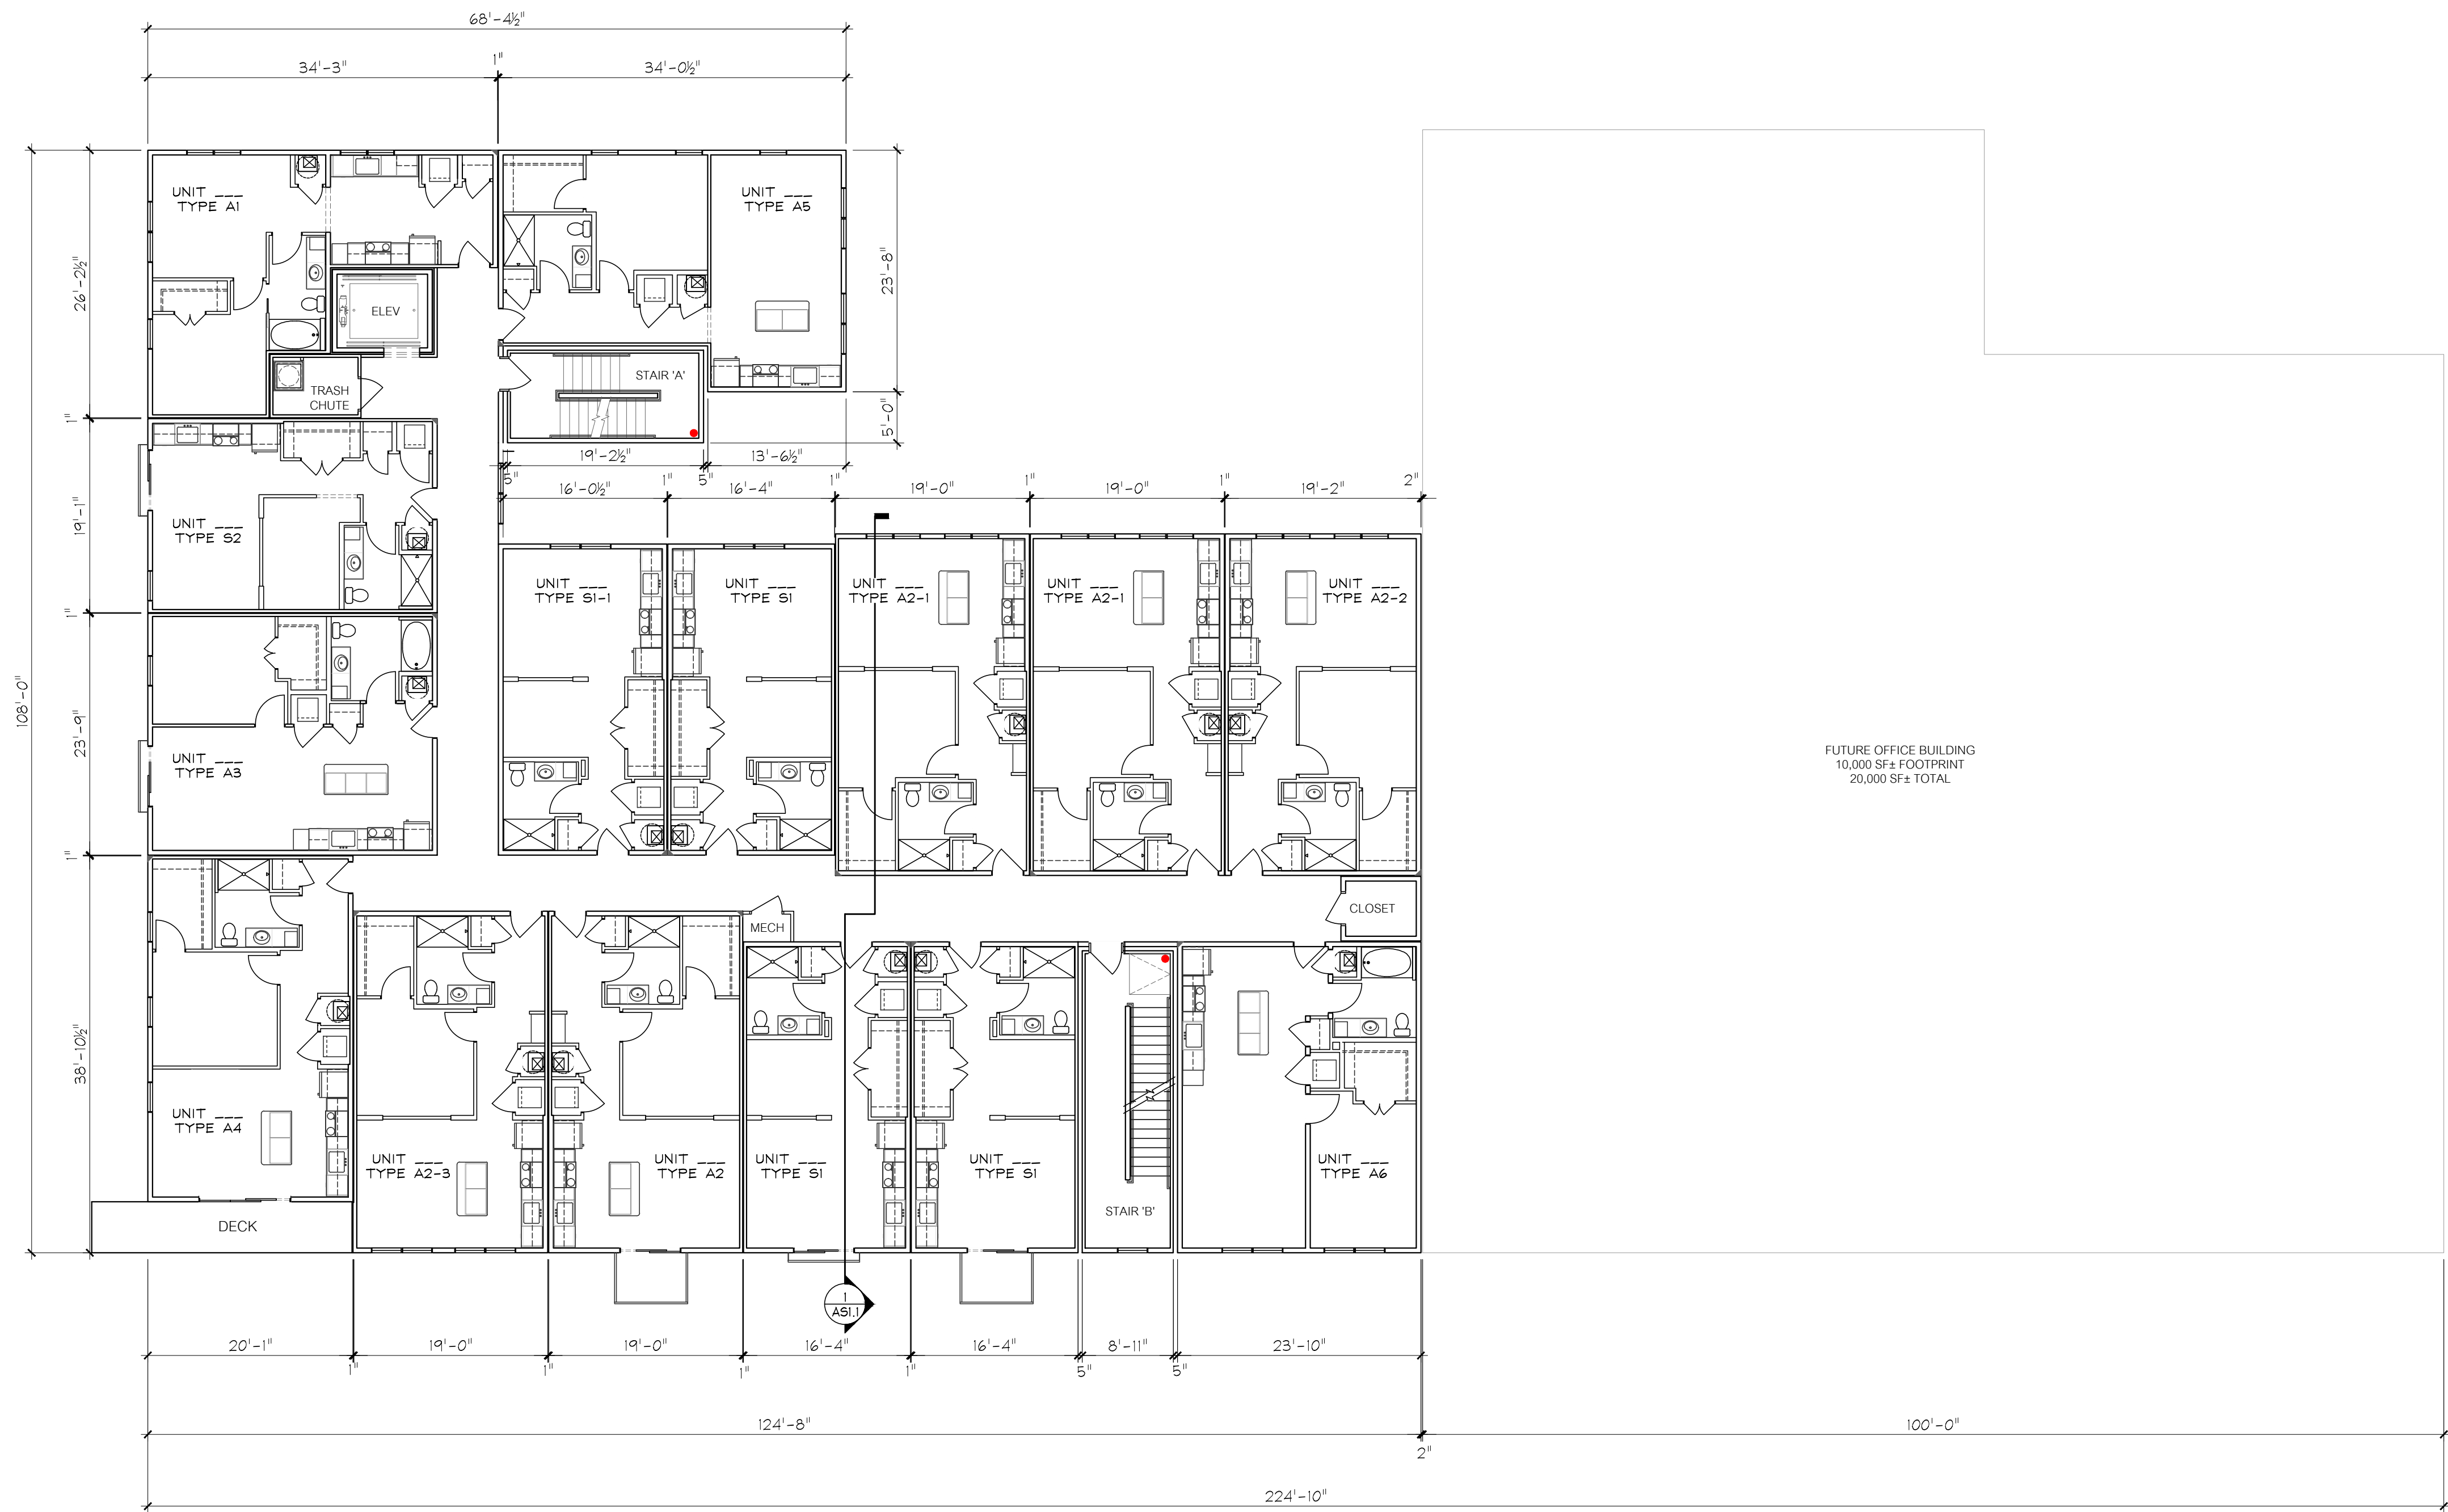
CHROMA II  
MIXED-USE DEVELOPMENT  
(CONCEPT 2.3)

ST. LOUIS, MO

NO	REVISIONS	DATE


DRAWING TITLE  
FLOOR PLAN - LEVEL 3

PROJECT #	DRAWING NUMBER
850	A1.3
DATE	DESIGN DEVELOPMENT
02/22/19	



FUTURE OFFICE BUILDING  
10,000 SF± FOOTPRINT  
20,000 SF± TOTAL

- BUILDING FLOOR PLAN NOTES:
1. ALL DIMENSIONS ARE TO FACE OF STUD (UNO).
  2. SEE ENLARGED UNIT & STAIR PLANS FOR DETAILED INFORMATION NOT SHOWN.
  3. ■ INDICATES REFERENCE POINT FOR UNIT ORIENTATION & DIMENSIONAL LAYOUT.
  4. SEE BUILDING ELEVATIONS FOR EXTERIOR FINISH MATERIALS.
  5. SEE FRAMING ELEVATIONS & SECTIONS FOR WALL HEIGHTS, FLOOR-TO-FLOOR HEIGHTS, PARAPET HEIGHTS, ETC.
  6. FINISH SPECIFICATIONS ARE BY OWNER / GC.
  7. SEE ENLARGED UNIT PLANS FOR FLOOR FINISH & ASSEMBLIES INSIDE UNITS.
  8. (8'-11" AFF) INDICATES CEILING HEIGHT FROM TOP OF SLAB OR GYP-CRETE TO BOTTOM OF GYPSUM CEILING.
  9. SEE G SHEETS (FIRE PROTECTION) FOR FIRE RATED WALLS AND OPENINGS.
  10. ■ INDICATES CLASS I STANDPIPE INSTALLED PER IBC SECTION 905 & NFPA 14. SEE SPRINKLER DESIGN DRAWINGS FOR MORE INFORMATION.
  11. COMMON WALLS NOT SHOWN IN ENLARGED PLANS ARE 2x4 (UNO). STUDS TO BE SPACED @ 16" OC (SPF STUD). PLATES TO BE #2 (TREATED @ CONCRETE).
  12. FLOORING OVER CONCRETE OR 1" GYP-CRETE IN COMMON AREAS TO BE SPECIFIED BY OWNER / GC.
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MO CERTIFICATE OF AUTHORITY #2019004334 (ARCHITECTURE)

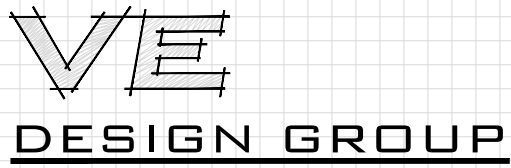**CHROMA II  
MIXED-USE DEVELOPMENT  
(CONCEPT 2.3)**


ST. LOUIS, MO

NO	REVISIONS	DATE


DRAWING TITLE

FLOOR PLAN - LEVEL 4

PROJECT #	DRAWING NUMBER
850	A1.4
DATE	DESIGN DEVELOPMENT
02/22/19	

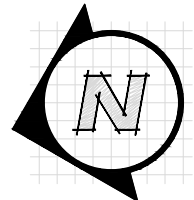


FLOOR PLAN - LEVEL 4  
Scale: 3/32" = 1'-0"

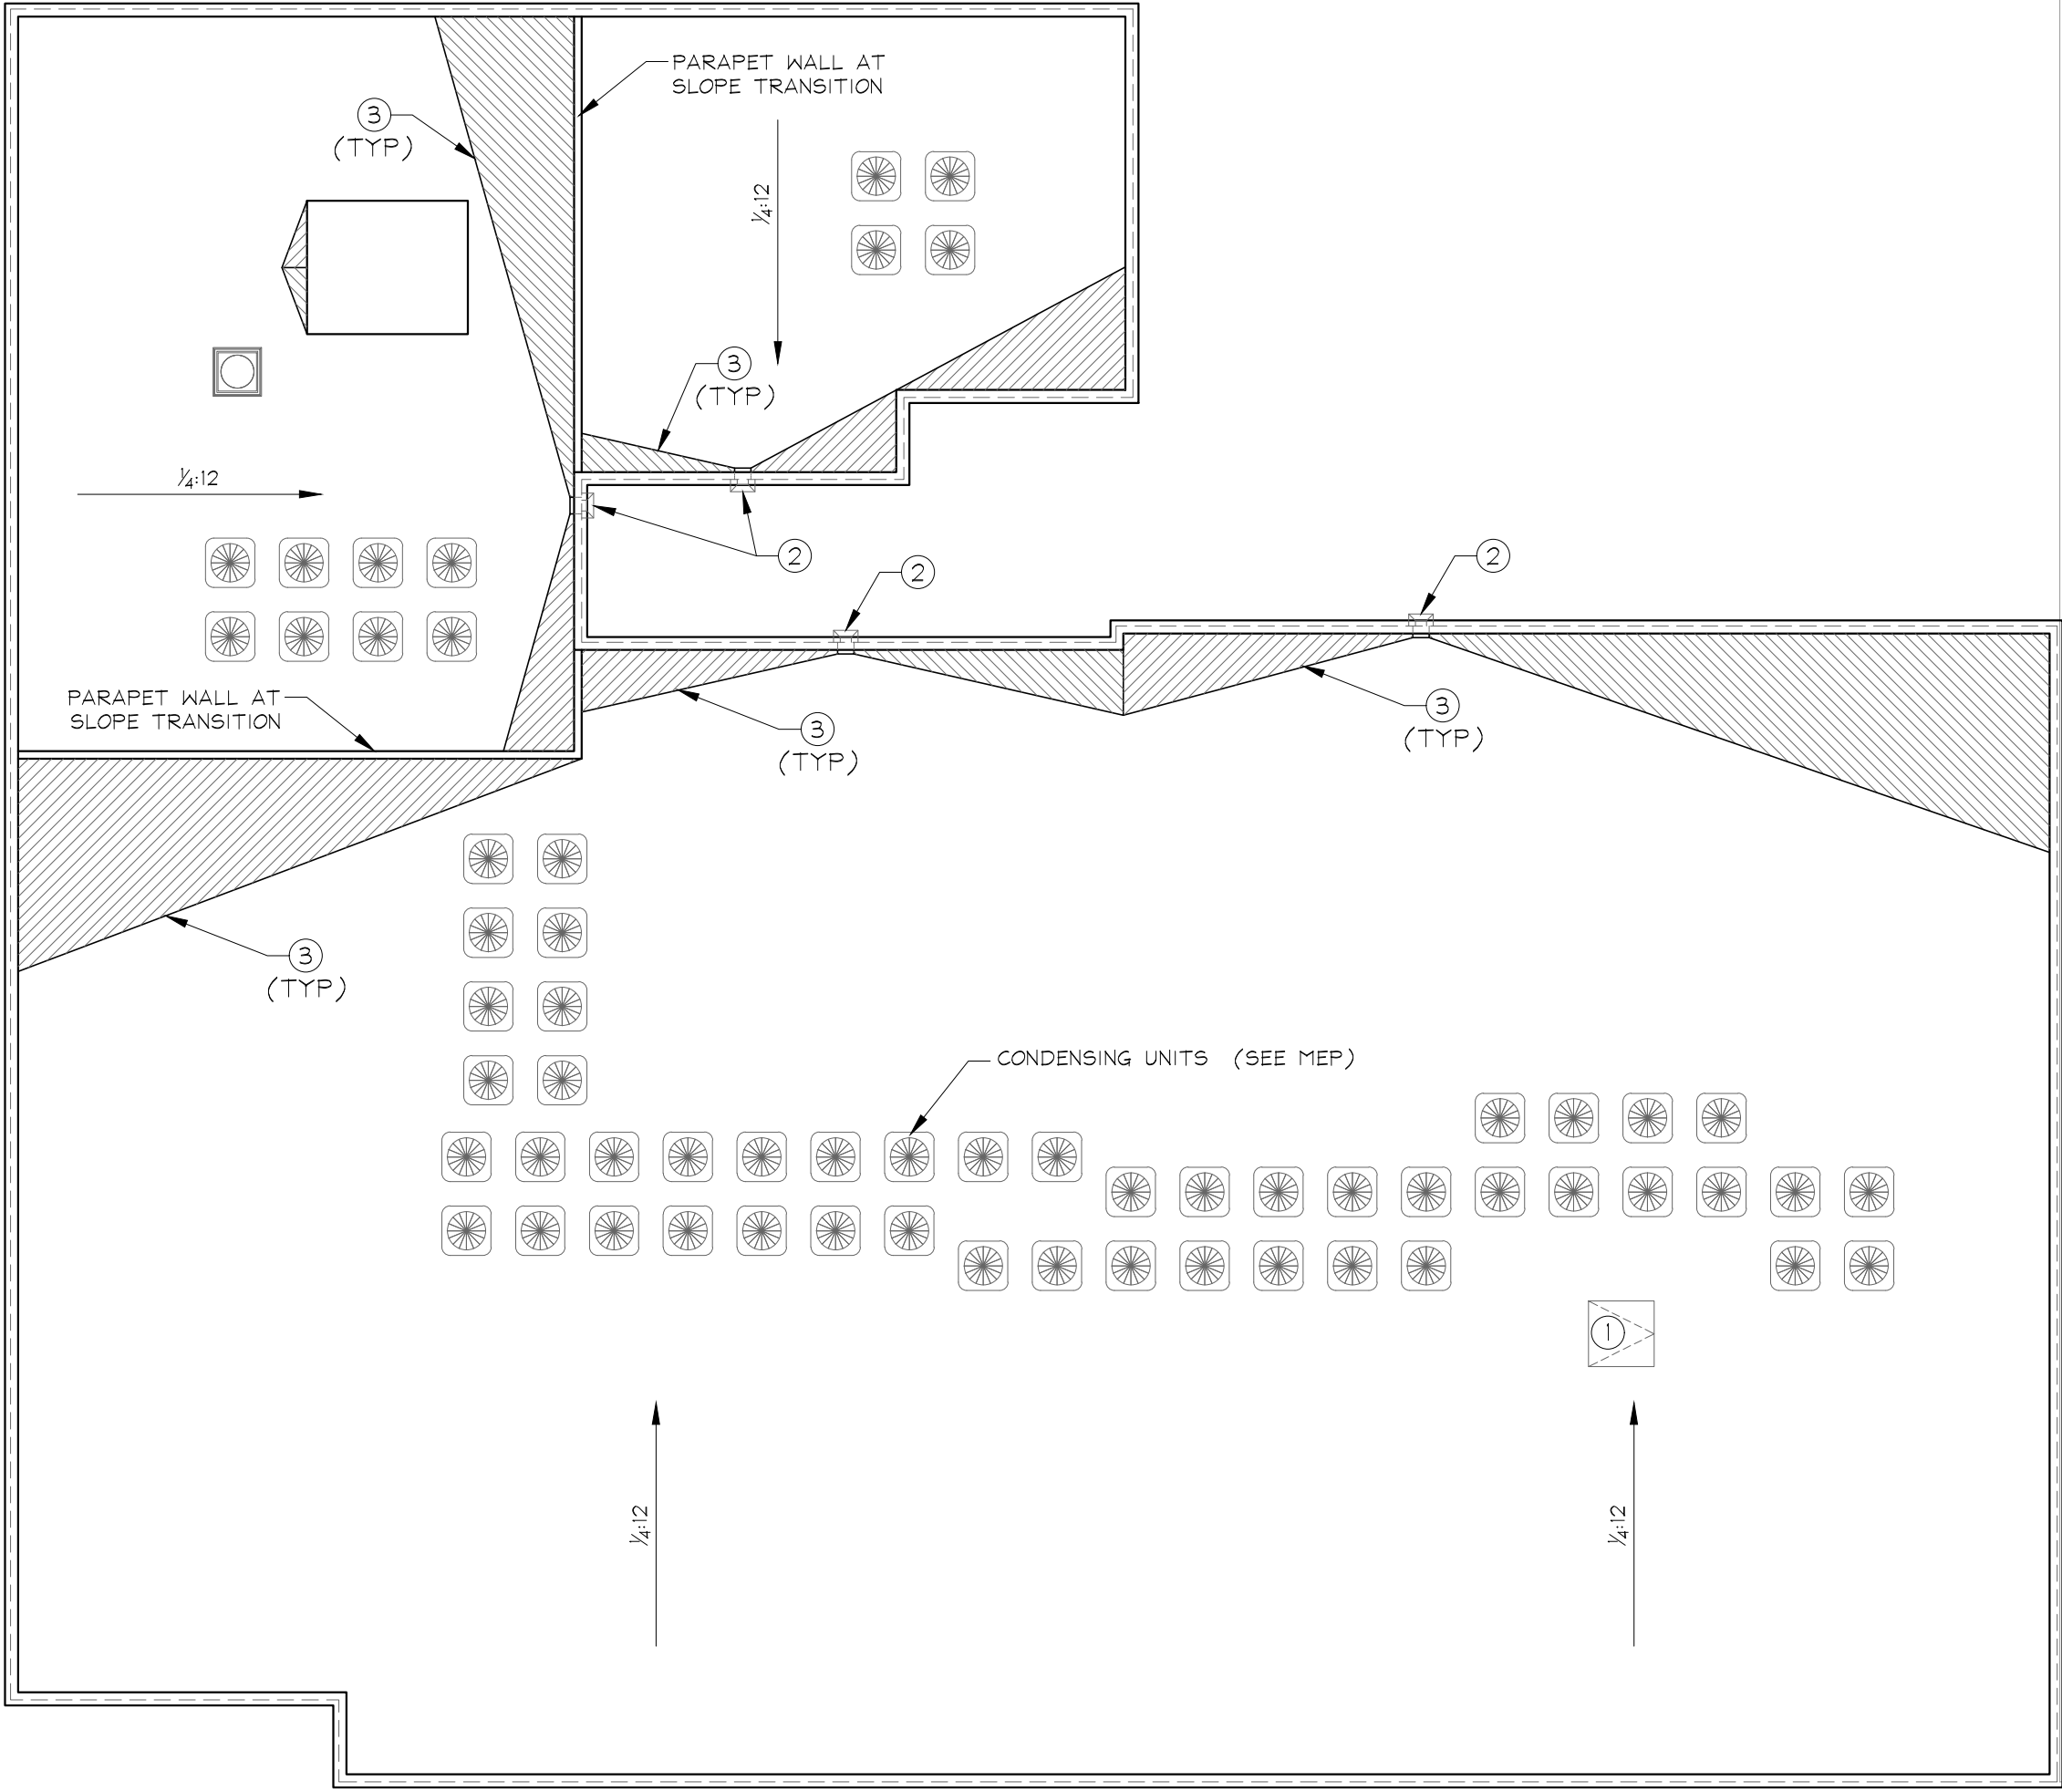

- ROOF PLAN NOTES:
1. ALL ROOFING IS FULLY ADHERED EPDM ROOF SYSTEM OVER RIGID INSULATION (UNO). ALL ROOFING SHALL CARRY A MANUFACTURER'S WARRANTY OF 20 YEARS. SEE BUILDING SECTIONS FOR INSULATION REQUIREMENTS.
  2. INSTALL ALL ROOFING, FLASHING, CAPS, AND SEALANTS IN ACCORDANCE WITH MANUFACTURER'S INSTALLATION REQUIREMENTS.
  3. COORDINATE ALL ROOF PENETRATIONS WITH MECHANICAL, ELECTRICAL, AND PLUMBING TRADES. PROVIDE AND INSTALL ALL FLASHING, CURBS, BLOCKING, AND OTHER RELATED ITEMS IN ACCORDANCE WITH MANUFACTURER'S REQUIREMENTS TO ACHIEVE A WATER-TIGHT INSTALLATION.
  4. PROVIDE SECONDARY DRAINS (EMERGENCY OVERFLOW) ABOVE MAIN ROOF DRAINS. SEE DETAILS 11 & 15 / AS6.7. SUBCONTRACTOR TO SUBMIT PROPOSED DETAILS TO ARCHITECT FOR APPROVAL PRIOR TO INSTALLATION.
  5. ALL MECHANICAL EQUIPMENT AND ROOF HATCH OPENINGS MUST BE PLACED 10'-0" FROM EDGE OF ROOF (MINIMUM).

- KEY NOTES (ROOF PLAN):
- ① 4'-0" x 4'-0" ROOF HATCH WITH BUILT-IN OPENING PROTECTION (MINIMUM 16 SQUARE FEET PER IBC 1009.16.1, EXCEPTION)
  - ② 1'-0" x 6" OPENING FOR SCUPPER TO 4" x 5" DOWNSPOUT (SEE 11 & 15 / AS4.2)
  - ③ TAPERED INSULATION BOARD (CRICKETS)

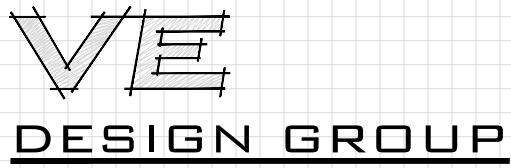


520 E. JACKSON ST., SUITE 2  
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MO CERTIFICATE OF AUTHORITY #2019004334 (ARCHITECTURE)

CHROMA II  
MIXED-USE DEVELOPMENT  
(CONCEPT 2.3)

ST. LOUIS, MO

NO	REVISIONS	DATE

DRAWING TITLE	
ROOF PLAN	
PROJECT #	DRAWING NUMBER
850	A1.5
DATE	DESIGN DEVELOPMENT
02/22/19	

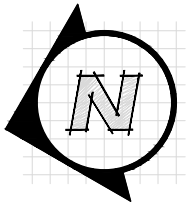

ROOF PLAN  
Scale: 3/32" = 1'-0"

Bldg	Elevation	Brick (B1&B2)			Metal Panel (S1&S2)			Fiber Cement Plank Siding (S3)		
		Area	Openings	Actual	Area	Openings	Actual	Area	Openings	Actual
1	West	5,127	1,407	3,720	627	221	406	-	-	-



RENDERED ELEVATION - WEST  
Scale: 3/32" = 1'-0"

Bldg	Elevation	Brick (B1&B2)			Metal Panel (S1&S2)			Fiber Cement Plank Siding (S3)		
		Area	Openings	Actual	Area	Openings	Actual	Area	Openings	Actual
1	North	1,840	459	1,381	3,338	723	2,615	-	-	-



RENDERED ELEVATION - NORTH  
Scale: 3/32" = 1'-0"

ELEVATION NOTES:  
1. REFER TO SHEET 2.4 FOR MATERIAL KEYNOTE DESCRIPTIONS.

04/11/19 CULTURAL  
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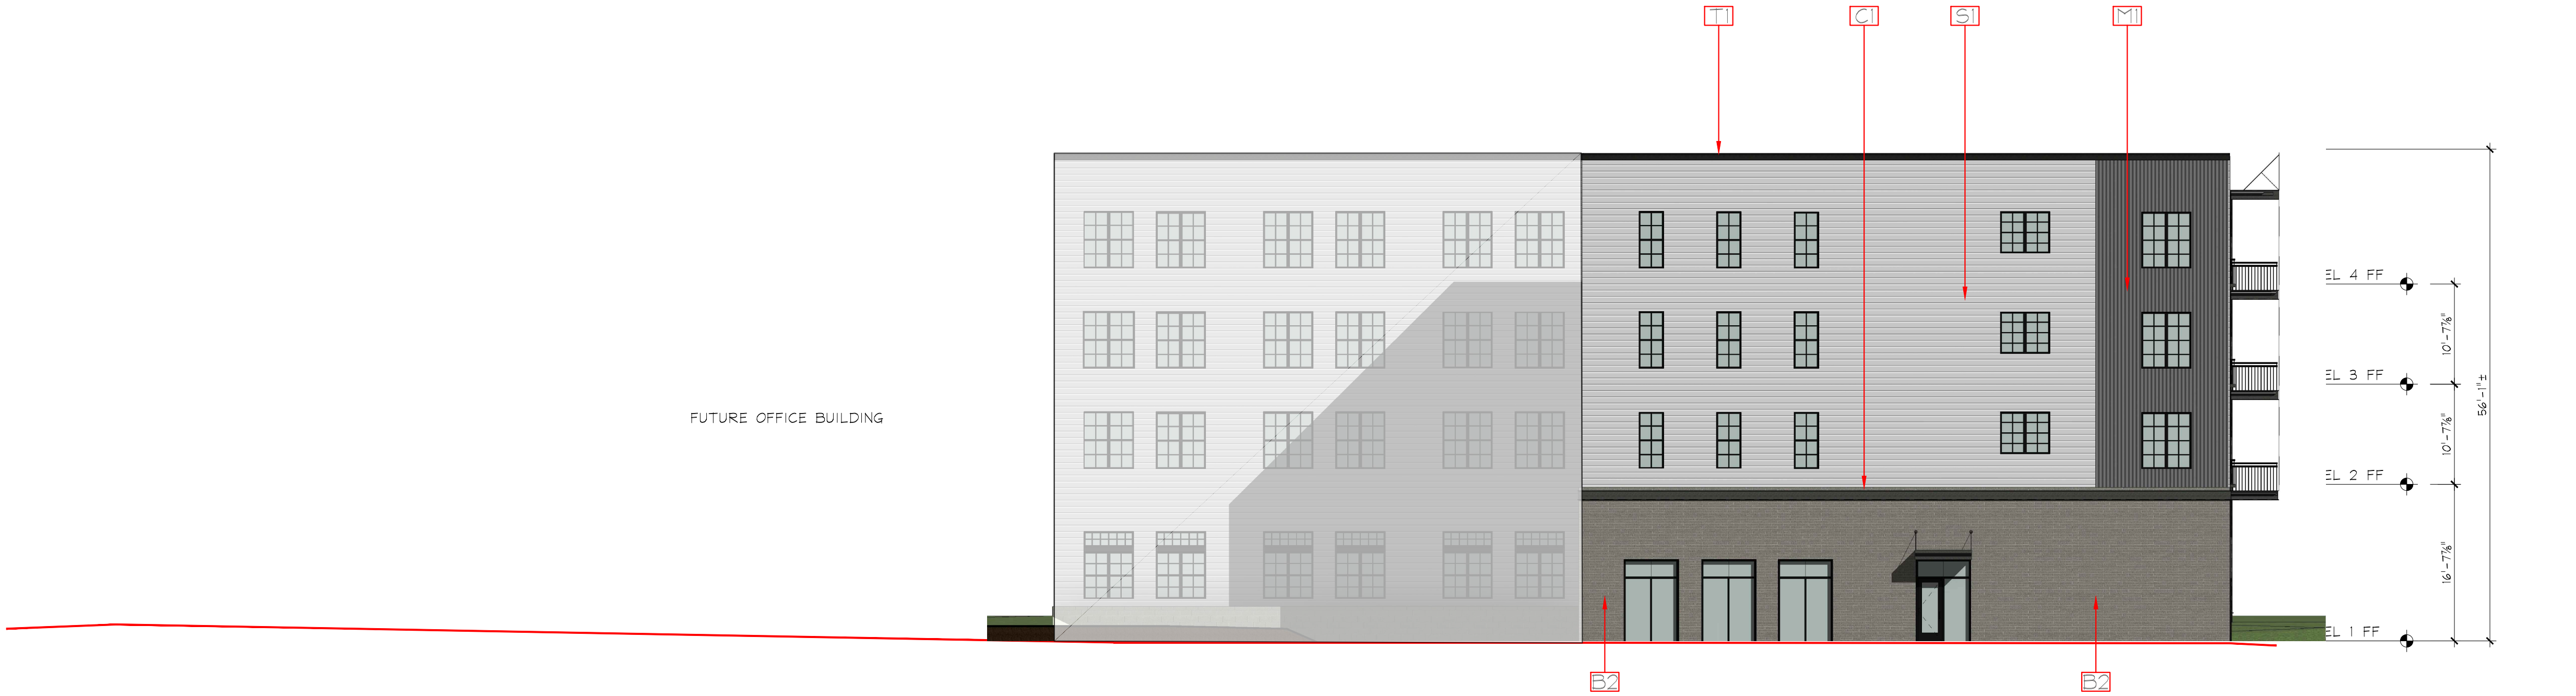
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CHROMA II  
MIXED-USE DEVELOPMENT  
(CONCEPT 2.3)

ST. LOUIS, MO		
NO	REVISIONS	DATE


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RENDERED ELEVATIONS	
PROJECT # 850	DRAWING NUMBER A2.1
DATE 04/11/19	DESIGN DEVELOPMENT

Bldg	Elevation	Brick (B1&B2)			Metal Panel (S1&S2)			Fiber Cement Plank Siding (S3)		
		Area	Openings	Actual	Area	Openings	Actual	Area	Openings	Actual
1	East	1,109	212	897	515	95	420	1,929	214	1,715



RENDERED ELEVATION - EAST  
Scale: 3/32" = 1'-0"

Bldg	Elevation	Brick (B1&B2)			Metal Panel (S1&S2)			Fiber Cement Plank Siding (S3)		
		Area	Openings	Actual	Area	Openings	Actual	Area	Openings	Actual
1	South	3,579	-	3,579	-	-	-	-	-	-

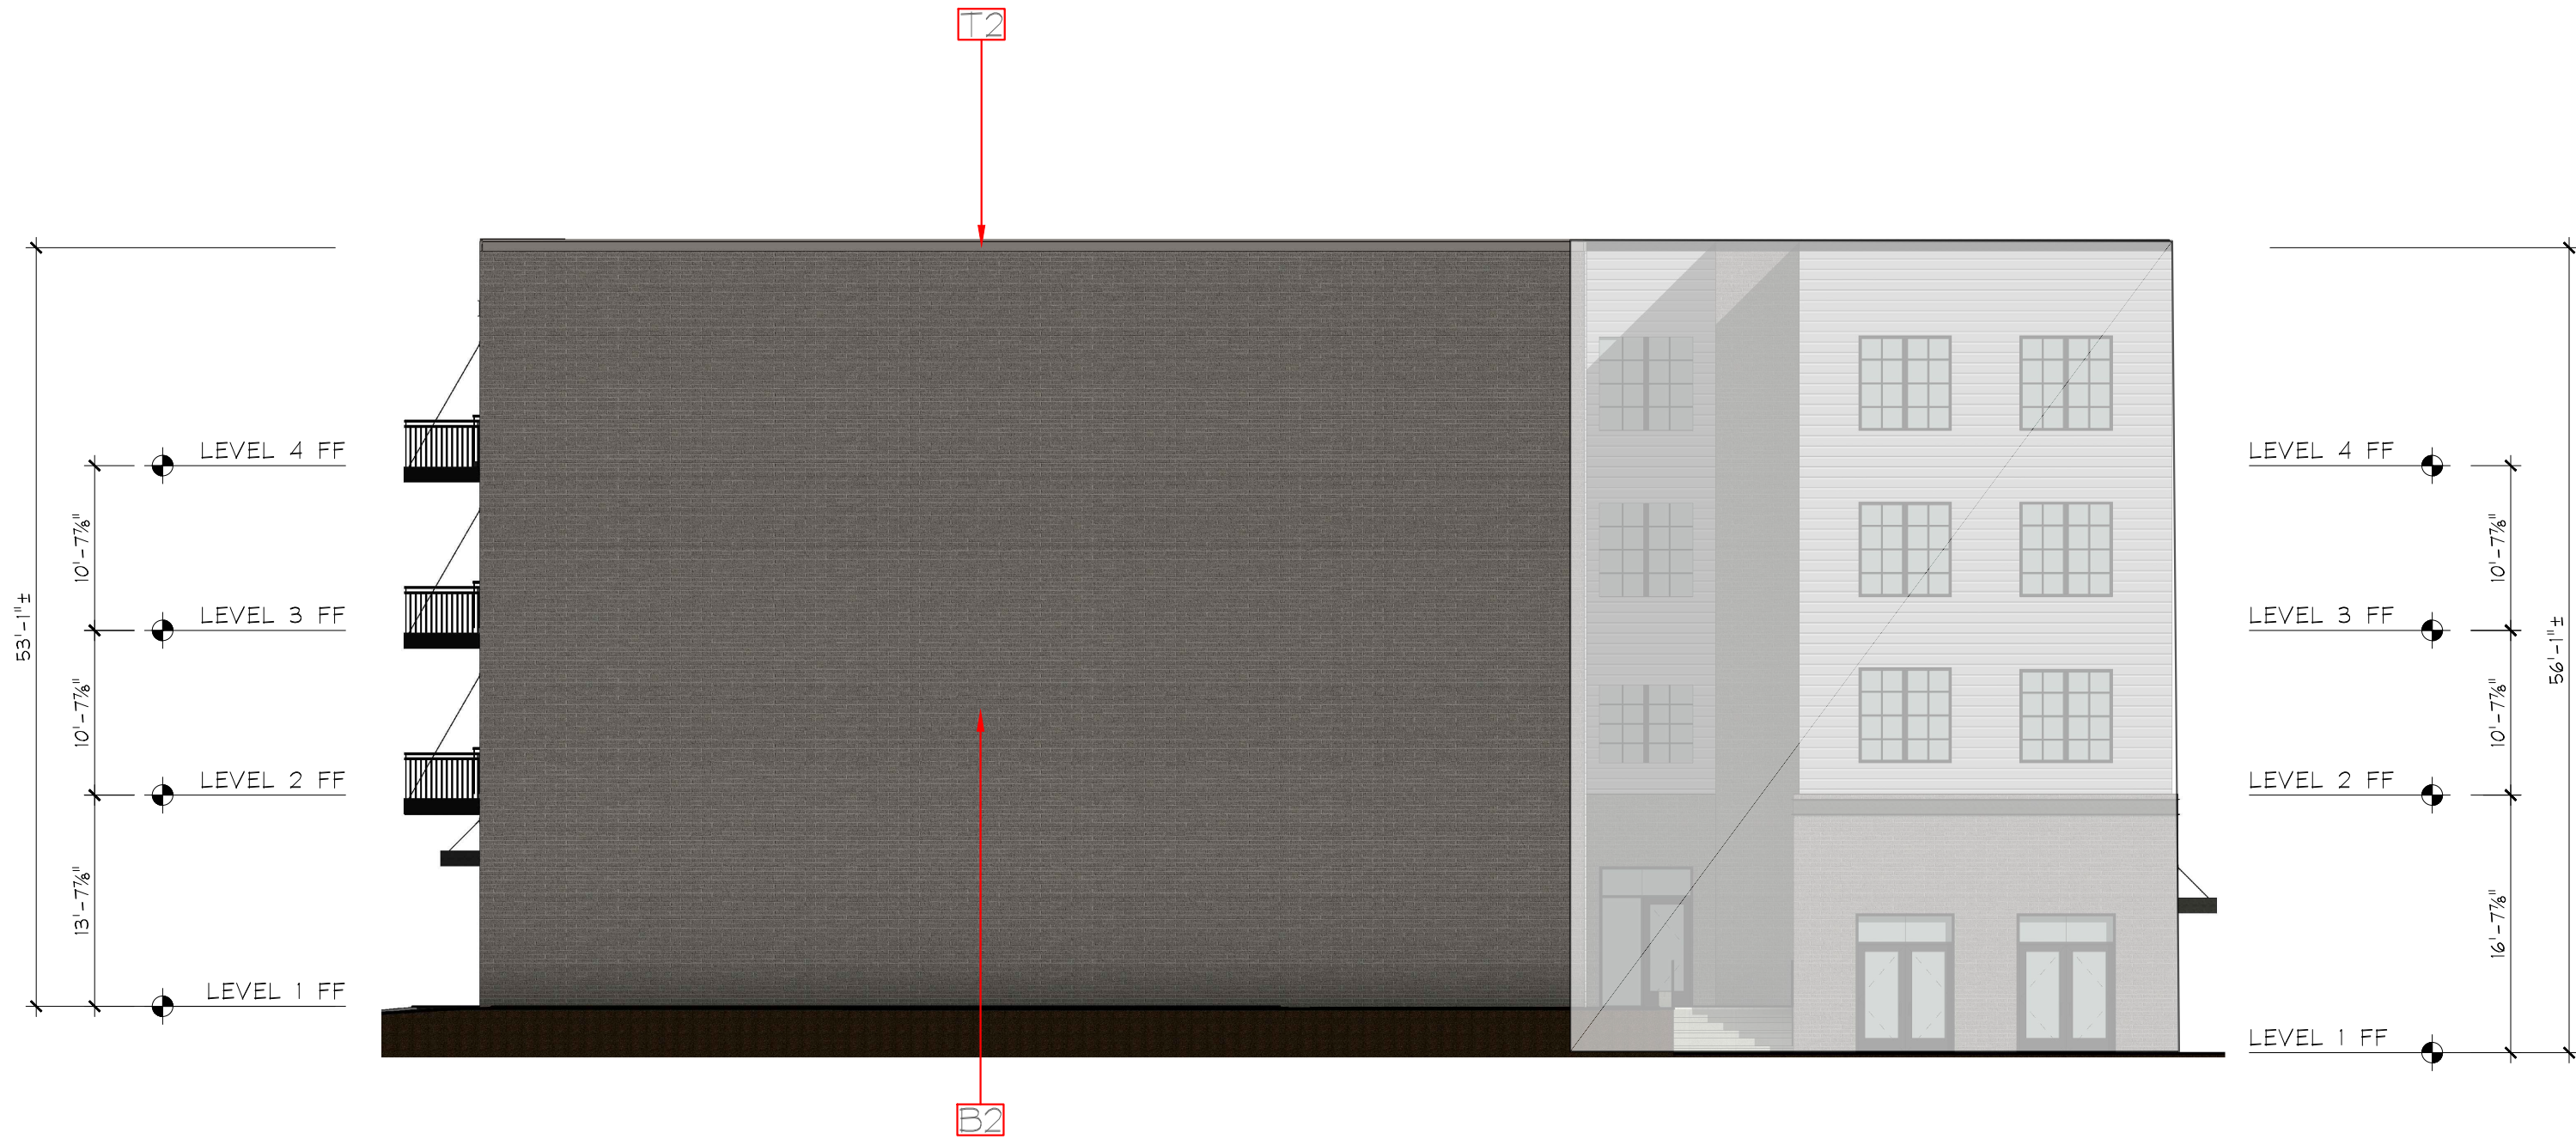

RENDERED ELEVATION - SOUTH  
Scale: 3/32" = 1'-0"

ELEVATION NOTES:  
1. REFER TO SHEET 2.4 FOR MATERIAL KEYNOTE DESCRIPTIONS.

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CHROMA II  
MIXED-USE DEVELOPMENT  
(CONCEPT 2.3)


ST. LOUIS, MO

NO	REVISIONS	DATE

DRAWING TITLE  
RENDERED ELEVATIONS

PROJECT # 850	DRAWING NUMBER A2.2
DATE 04/11/19	DESIGN DEVELOPMENT

Bldg	Elevation	Brick (B1&B2)			Metal Panel (S1&S2)			Fiber Cement Plank Siding (S3)		
		Area	Openings	Actual	Area	Openings	Actual	Area	Openings	Actual
1	East Courtyard	-	-	-	-	-	-	4,484	1,069	3,415
1	North Courtyard	777	168	609	-	-	-	1,197	322	875
1	West Courtyard	1,229	-	1,229			-	480	-	480

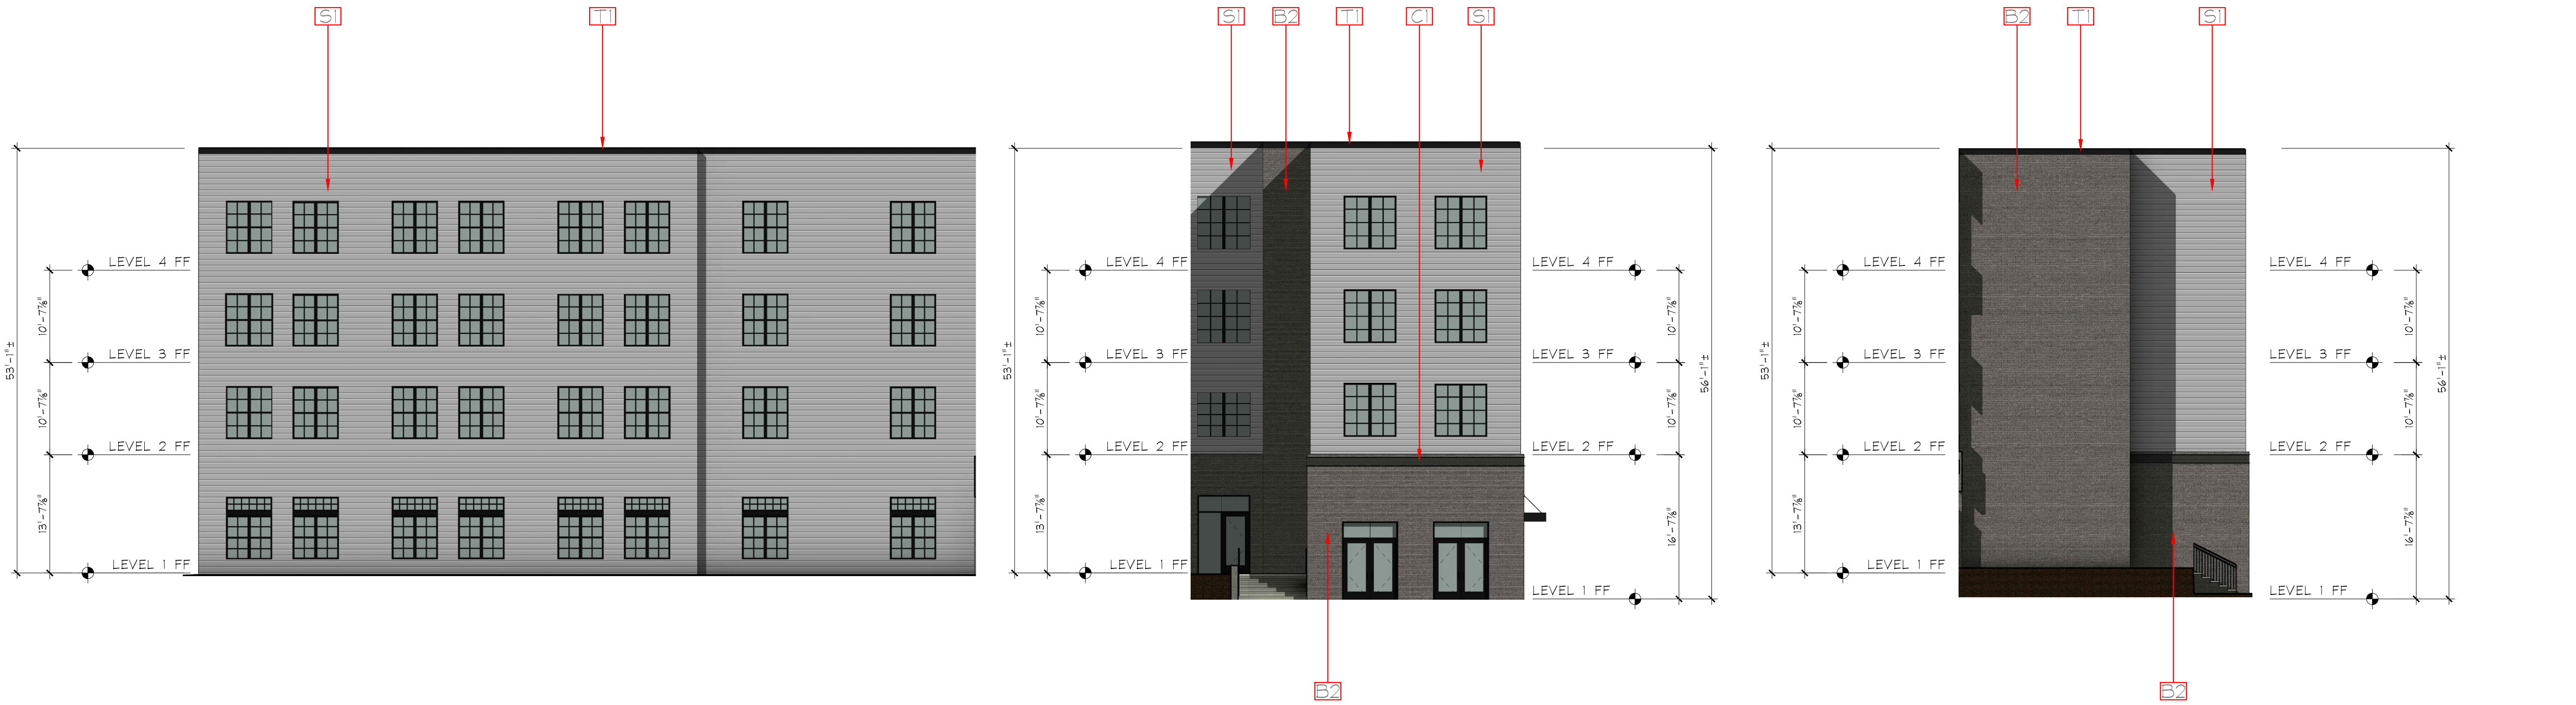

RENDERED ELEVATION - COURTYARD  
Scale: 3/32" = 1'-0"

ELEVATION NOTES:  
1. REFER TO SHEET 2.4 FOR MATERIAL KEYNOTE DESCRIPTIONS.

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CHROMA II  
MIXED-USE DEVELOPMENT  
(CONCEPT 2.3)

ST. LOUIS, MO

NO	REVISIONS	DATE

DRAWING TITLE  
RENDERED ELEVATIONS

PROJECT # 850	DRAWING NUMBER A2.3
DATE 04/11/19	DESIGN DEVELOPMENT

# PROPOSED MATERIALS & COLORS

**SW 6258**  
**Tricorn Black**  
Interior / Exterior  
Locator Number: 251-C1

PARAPET CAP, BALCONY RAILS,  
AWNINGS, & STEEL CHANNEL  
PAINTED STEEL OR ALUM.

C1 T1

**SW 7023**  
**Requisite Gray**  
Interior / Exterior  
Locator Number: 241-C2

HARDIEPLANK FIBER CEMENT LAP SIDING &  
PARAPET CAP

S1 T2



CORRUGATED METAL PANEL  
AND TRIM EQUAL  
TO MBCI- SLATE GRAY

M1

CORRUGATED METAL  
PANEL AND TRIM  
EQUAL TO MBCI- CHARCOAL GRAY

M2



ACME KING BRICK(167)-STEELE  
GRAY VELOUR W/ SPEC MIX SM750  
(SILVERSTONE) MORTAR

B1



ACME KING BRICK(166)-MARBLE  
GRAY VELOUR W/ SPEC MIX SM750  
(SILVERSTONE) MORTAR

B2



ACME KING BRICK(167)-SLATE  
GRAY VELOUR W/ SPEC MIX SM750  
(SILVERSTONE) MORTAR

B3

WINDOWS & STOREFRONTS  
DARK BRONZE OR BLACK ALUM. STOREFRONT OR  
VINYL DIVIDED LIGHT WINDOWS

\*ALL FINISHES SUBJECT TO MOCK UP WALL  
APPROVAL BY OWNER AND GOVERNMENT  
JURISDICTION.

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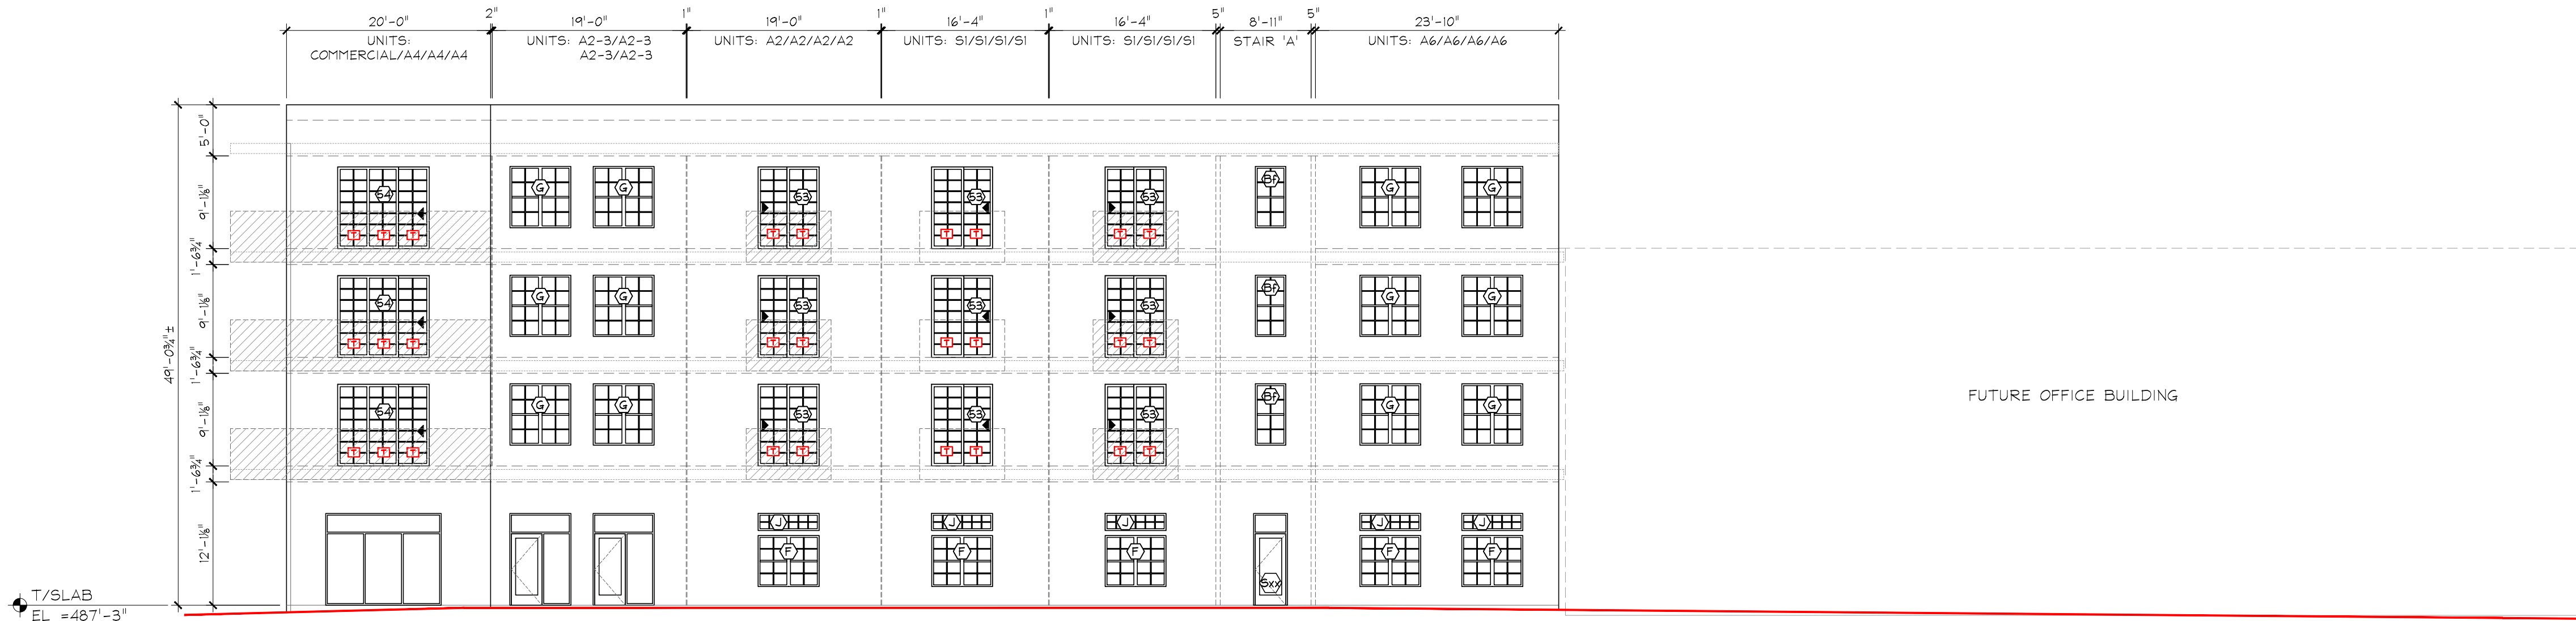
**CHROMA II**  
**MIXED-USE DEVELOPMENT**  
(CONCEPT 2.3)

ST. LOUIS, MO


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RENDERED ELEVATIONS



PROJECT #	DRAWING NUMBER
850	A2.4
DATE	DESIGN DEVELOPMENT
04/11/19	



FRAMING ELEVATION - WEST  
Scale: 3/32" = 1'-0"

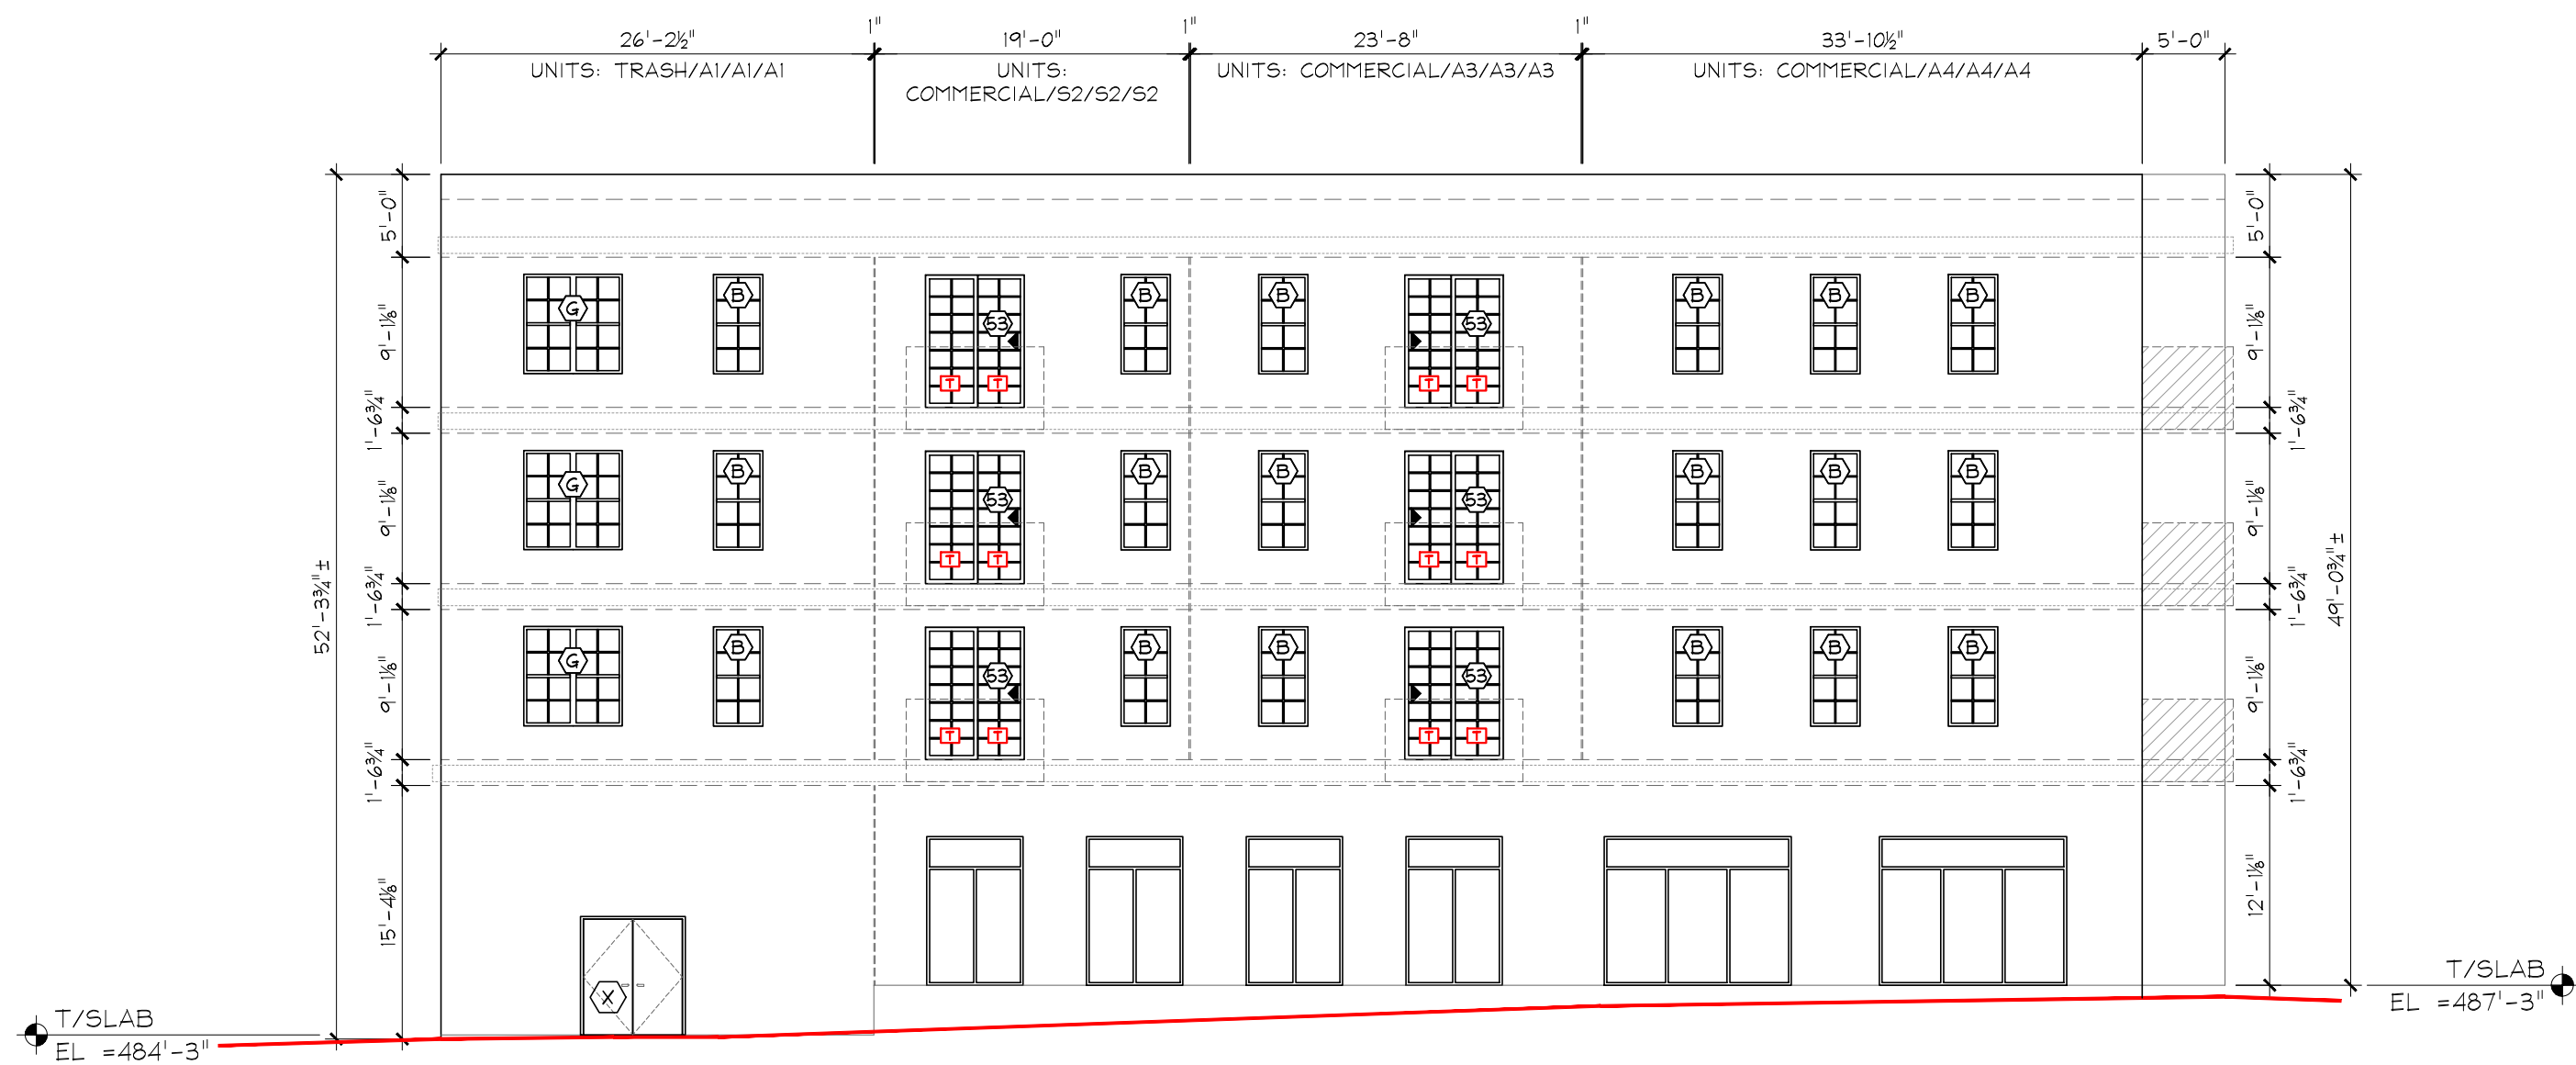

FRAMING ELEVATION - NORTH  
Scale: 3/32" = 1'-0"

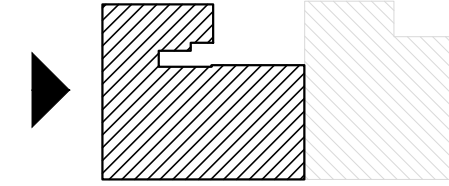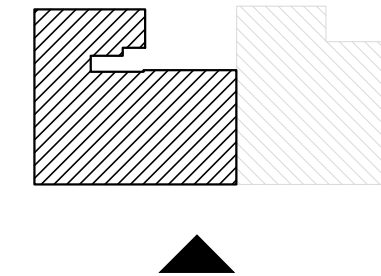

- FRAMING ELEVATION NOTES:
1. ALL DIMENSIONS ARE TO FACE OF STUD, TOP OF SUB-FLOOR, OR TOP OF PARAPET (UNO).
  2. ——— INDICATES GRADE LINE, SHOWN FOR CONCEPT ONLY. REFER TO CIVIL FOR ACTUAL GRADE ELEVATIONS.
  3. (Symbol) INDICATES DOOR OR WINDOW TYPE. SEE G5.1-G5.2 FOR SCHEDULES.
  4. (Symbol) INDICATES OPERABLE PANE AT SLIDING DOORS.
  5. (Symbol) INDICATES TEMPERED GLASS (SAFETY GLAZING) REQUIRED PER IBC 2406.4. SEE G5.3 FOR TEMPERED GLAZING AT STOREFRONTS.
  6. (Symbol) INDICATES JULIET RAIL (SEE PLANS).
  7. (Symbol) INDICATES STEEL BALCONY (SEE PLANS).

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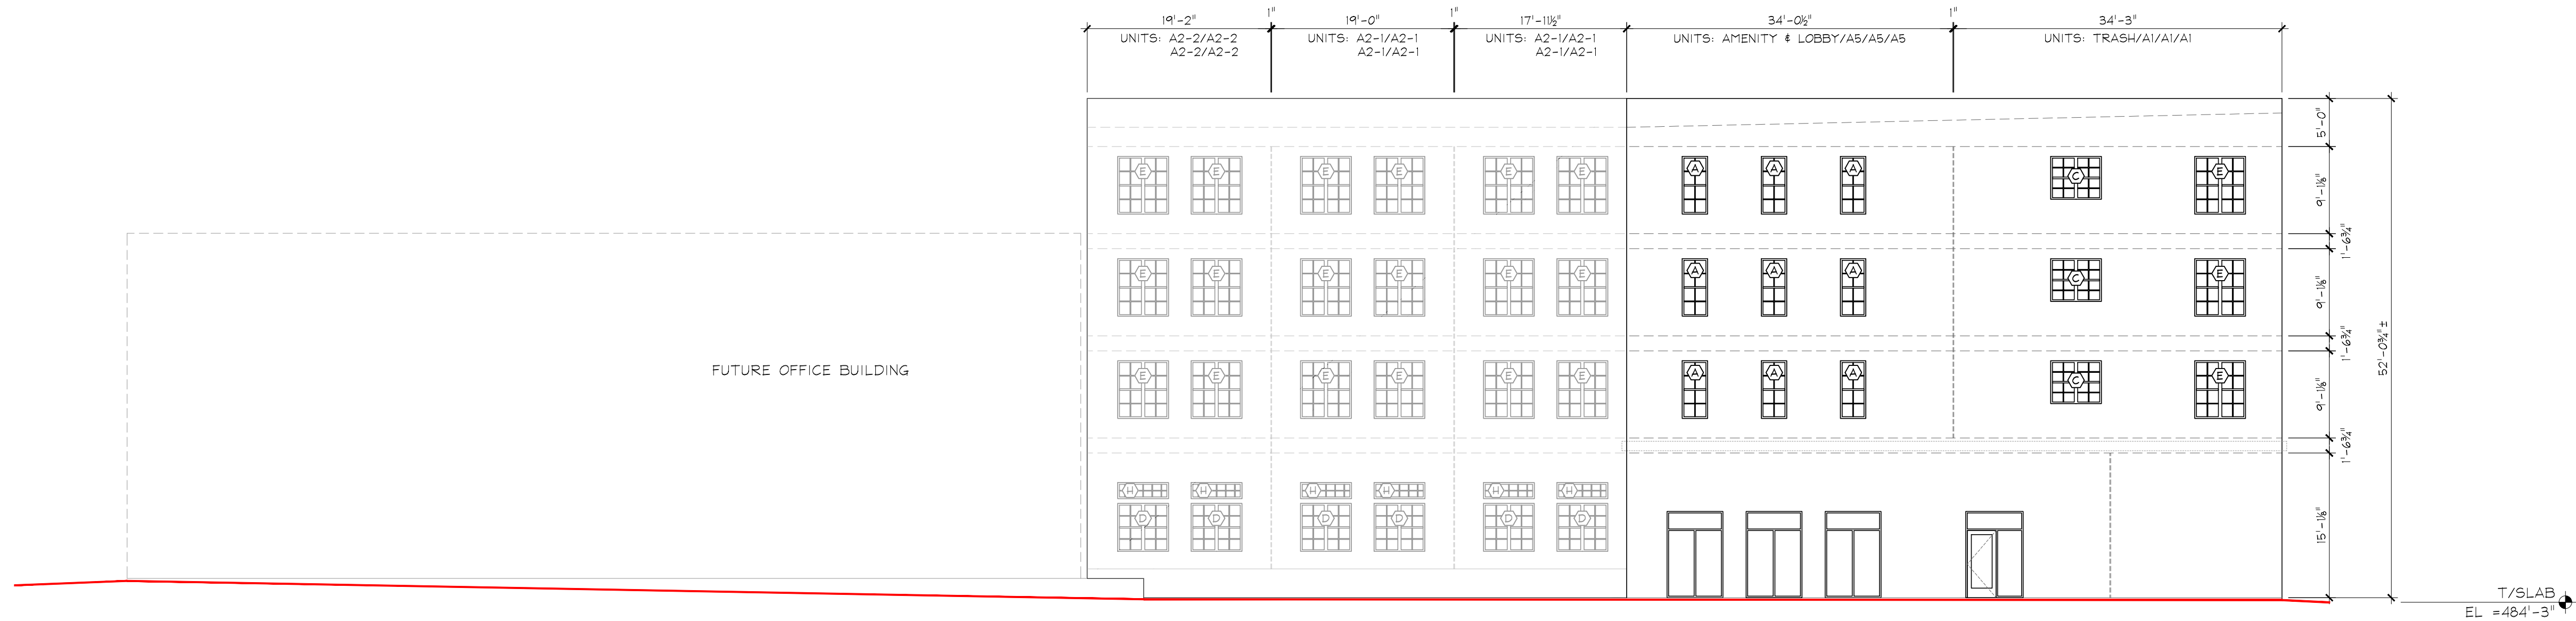
**CHROMA II  
MIXED-USE DEVELOPMENT  
(CONCEPT 2.3)**

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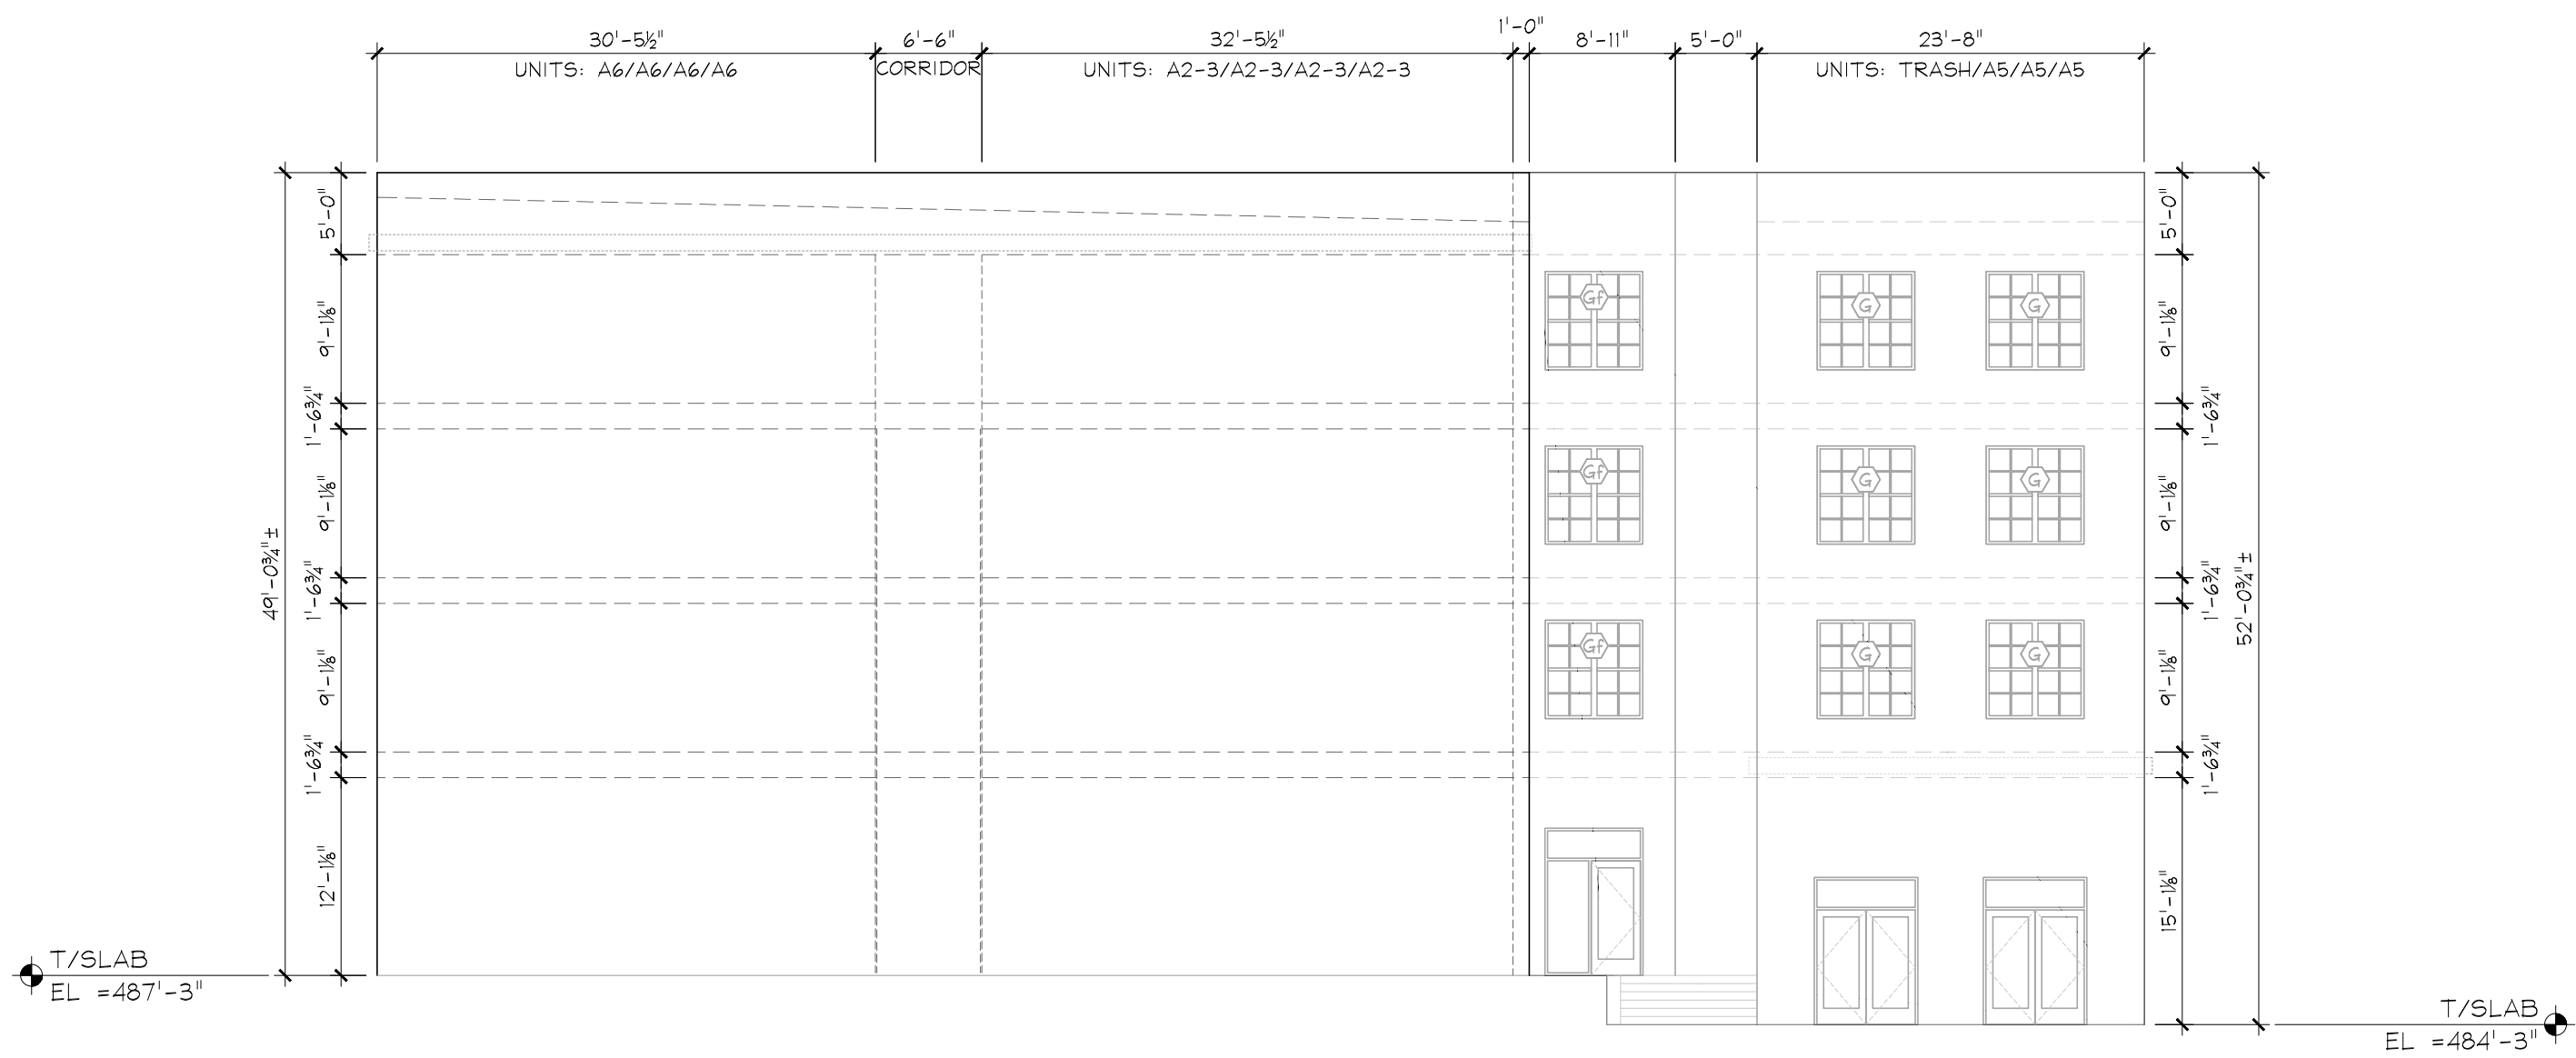
NO	REVISIONS	DATE

DRAWING TITLE  
FRAMING ELEVATIONS

PROJECT # 850	DRAWING NUMBER A3.1
DATE 02/22/19	DESIGN DEVELOPMENT



FRAMING ELEVATION - EAST  
Scale: 3/32" = 1'-0"



FRAMING ELEVATION - SOUTH  
Scale: 3/32" = 1'-0"

- FRAMING ELEVATION NOTES:
1. ALL DIMENSIONS ARE TO FACE OF STUD, TOP OF SUB-FLOOR, OR TOP OF PARAPET (UNO).
  2. — INDICATES GRADE LINE, SHOWN FOR CONCEPT ONLY. REFER TO CIVIL FOR ACTUAL GRADE ELEVATIONS.
  3. ⊕ INDICATES DOOR OR WINDOW TYPE. SEE G5.1-G5.2 FOR SCHEDULES.
  4. ◀ INDICATES OPERABLE PANE AT SLIDING DOORS.
  5. T INDICATES TEMPERED GLASS (SAFETY GLAZING) REQUIRED PER IBC 2406.4. SEE G5.3 FOR TEMPERED GLAZING AT STOREFRONTS.
  6. [Pattern] INDICATES JULIET RAIL (SEE PLANS).
  7. [Pattern] INDICATES STEEL BALCONY (SEE PLANS).

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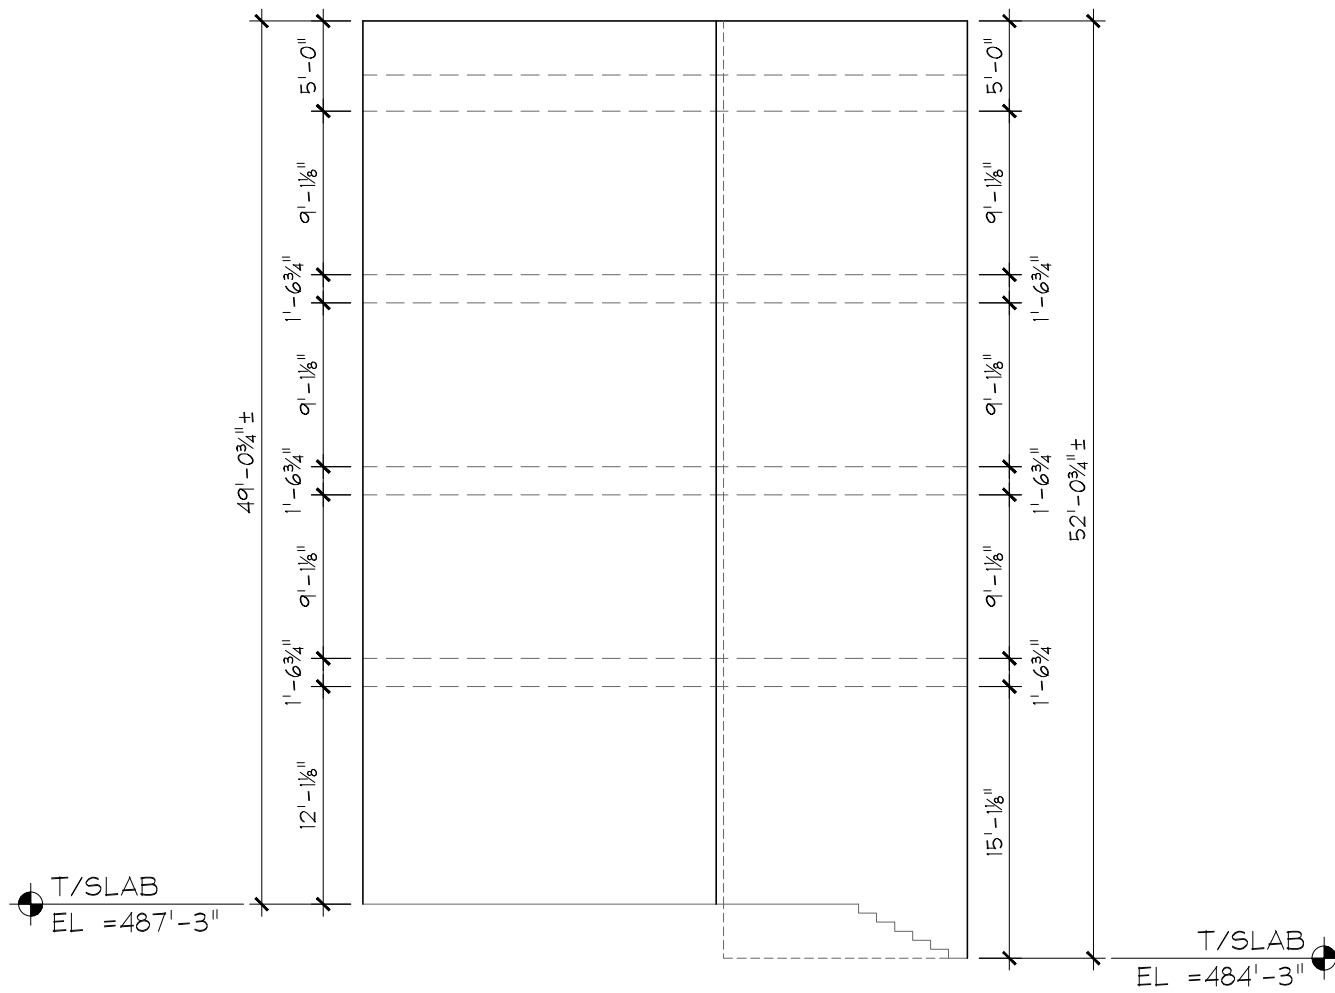
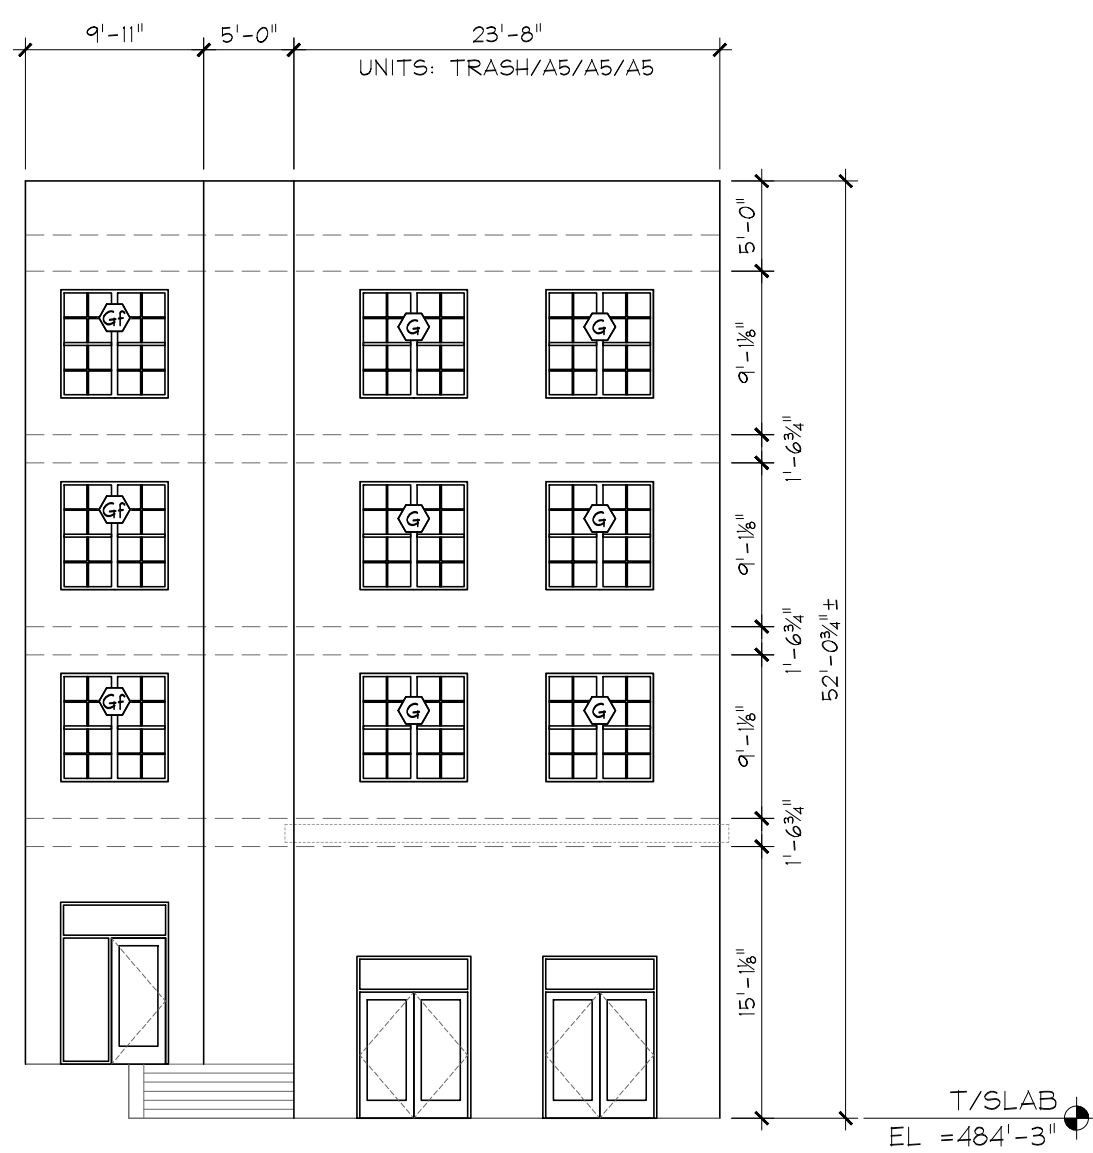
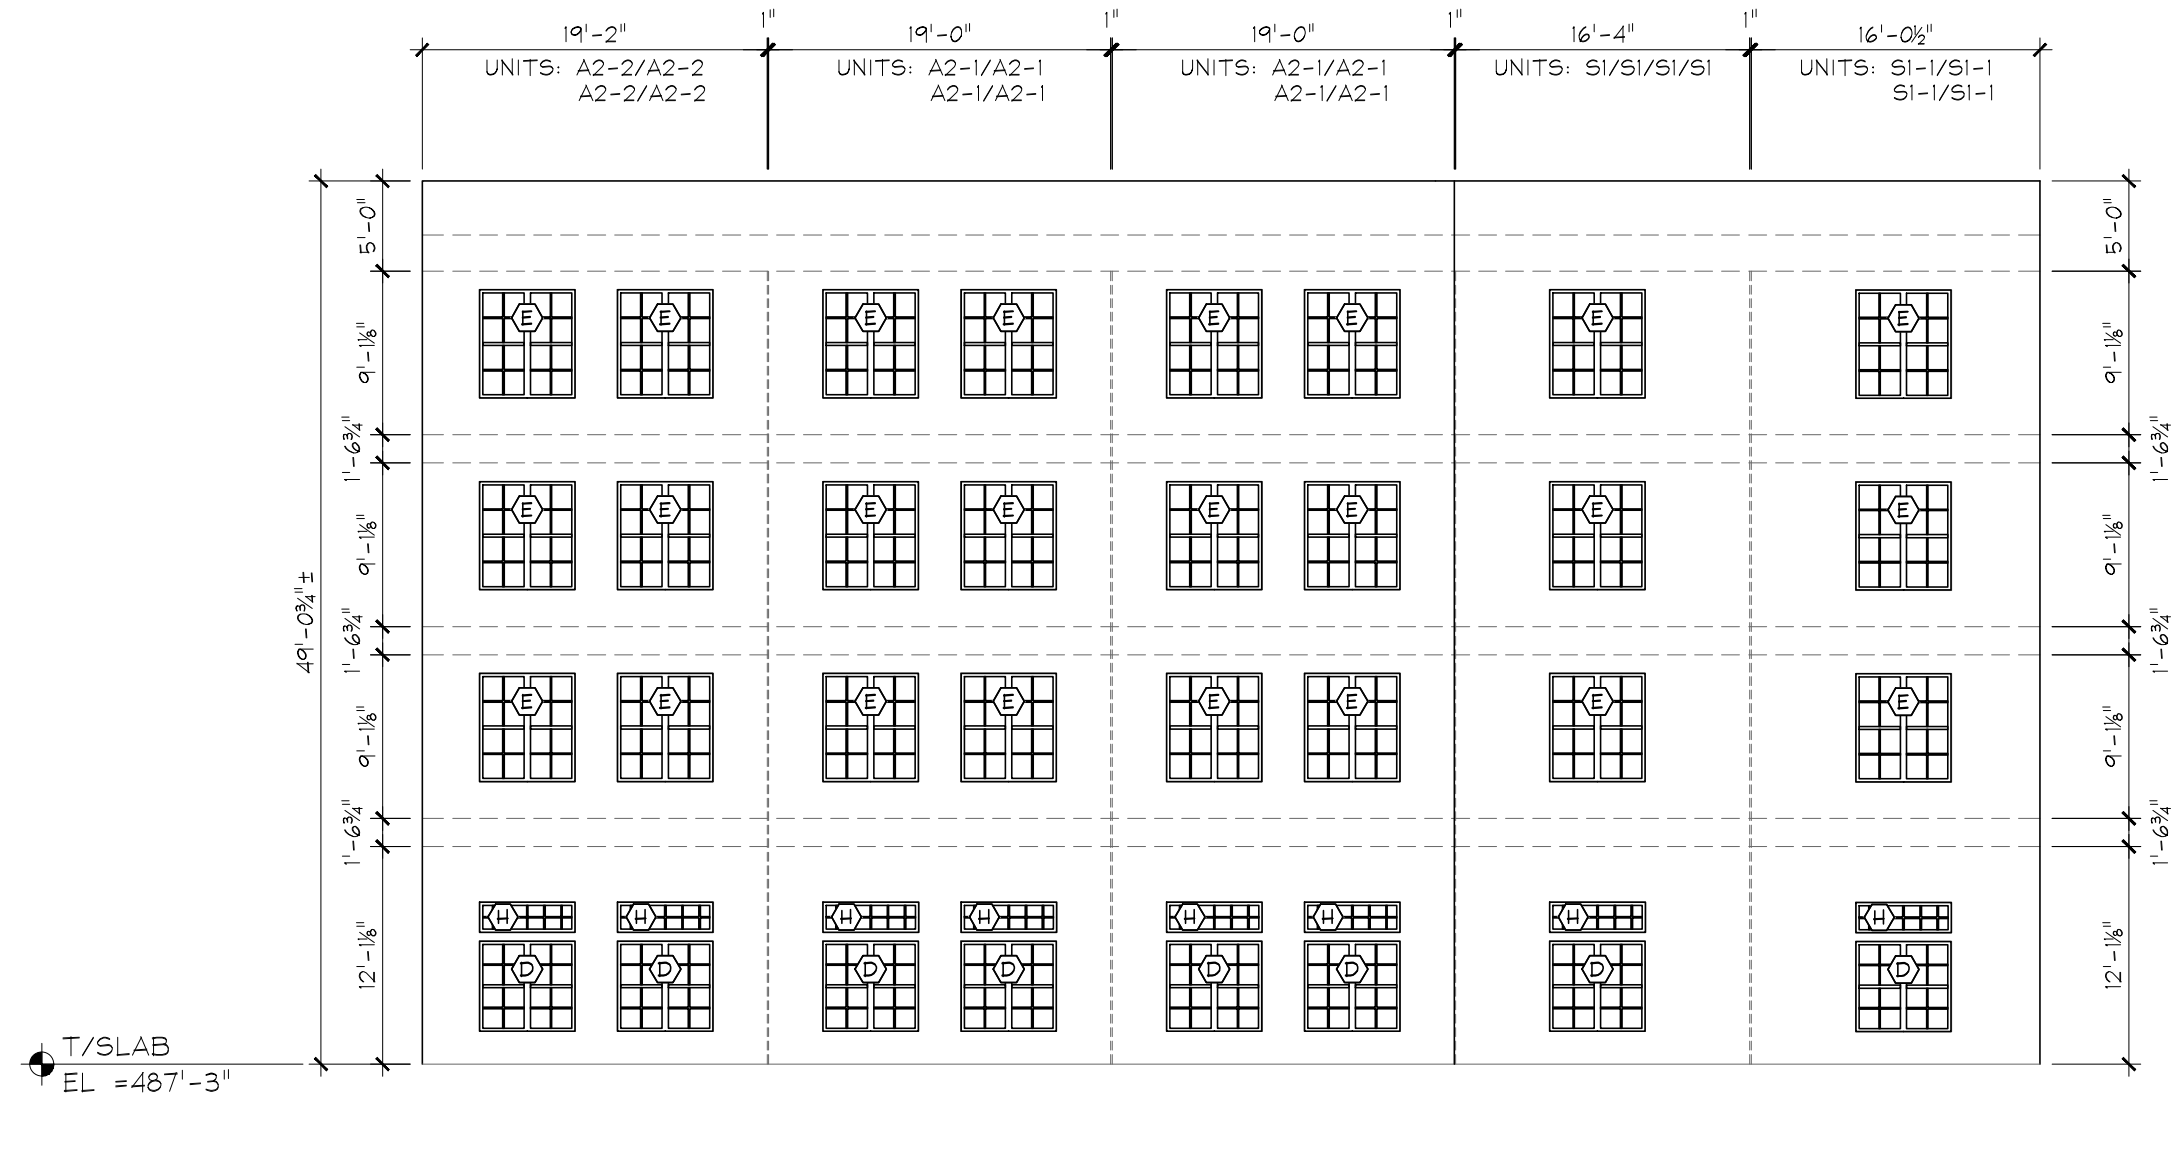
**CHROMA II**  
**MIXED-USE DEVELOPMENT**  
(CONCEPT 2.3)

ST. LOUIS, MO


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DRAWING TITLE  
FRAMING ELEVATIONS

PROJECT # 850	DRAWING NUMBER A3.2
DATE 02/22/19	DESIGN DEVELOPMENT



FRAMING ELEVATION - COURTYARD  
Scale: 3/32" = 1'-0"

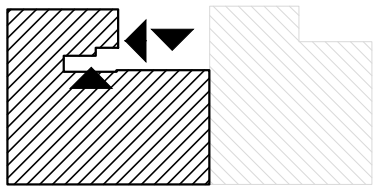

- FRAMING ELEVATION NOTES:
- ALL DIMENSIONS ARE TO FACE OF STUD, TOP OF SUB-FLOOR, OR TOP OF PARAPET (UNO).
  - INDICATES GRADE LINE, SHOWN FOR CONCEPT ONLY. REFER TO CIVIL FOR ACTUAL GRADE ELEVATIONS.
  - INDICATES DOOR OR WINDOW TYPE. SEE G5.1-G5.2 FOR SCHEDULES.
  - INDICATES OPERABLE PANE AT SLIDING DOORS.
  - INDICATES TEMPERED GLASS (SAFETY GLAZING) REQUIRED PER IBC 2406.4. SEE G5.3 FOR TEMPERED GLAZING AT STOREFRONTS.
  - INDICATES JULIET RAIL (SEE PLANS).
  - INDICATES STEEL BALCONY (SEE PLANS).

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**CHROMA II**  
**MIXED-USE DEVELOPMENT**  
(CONCEPT 2.3)


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NO	REVISIONS	DATE

DRAWING TITLE

FRAMING ELEVATIONS

PROJECT #	DRAWING NUMBER
850	A3.3
DATE	DESIGN DEVELOPMENT
02/22/19	

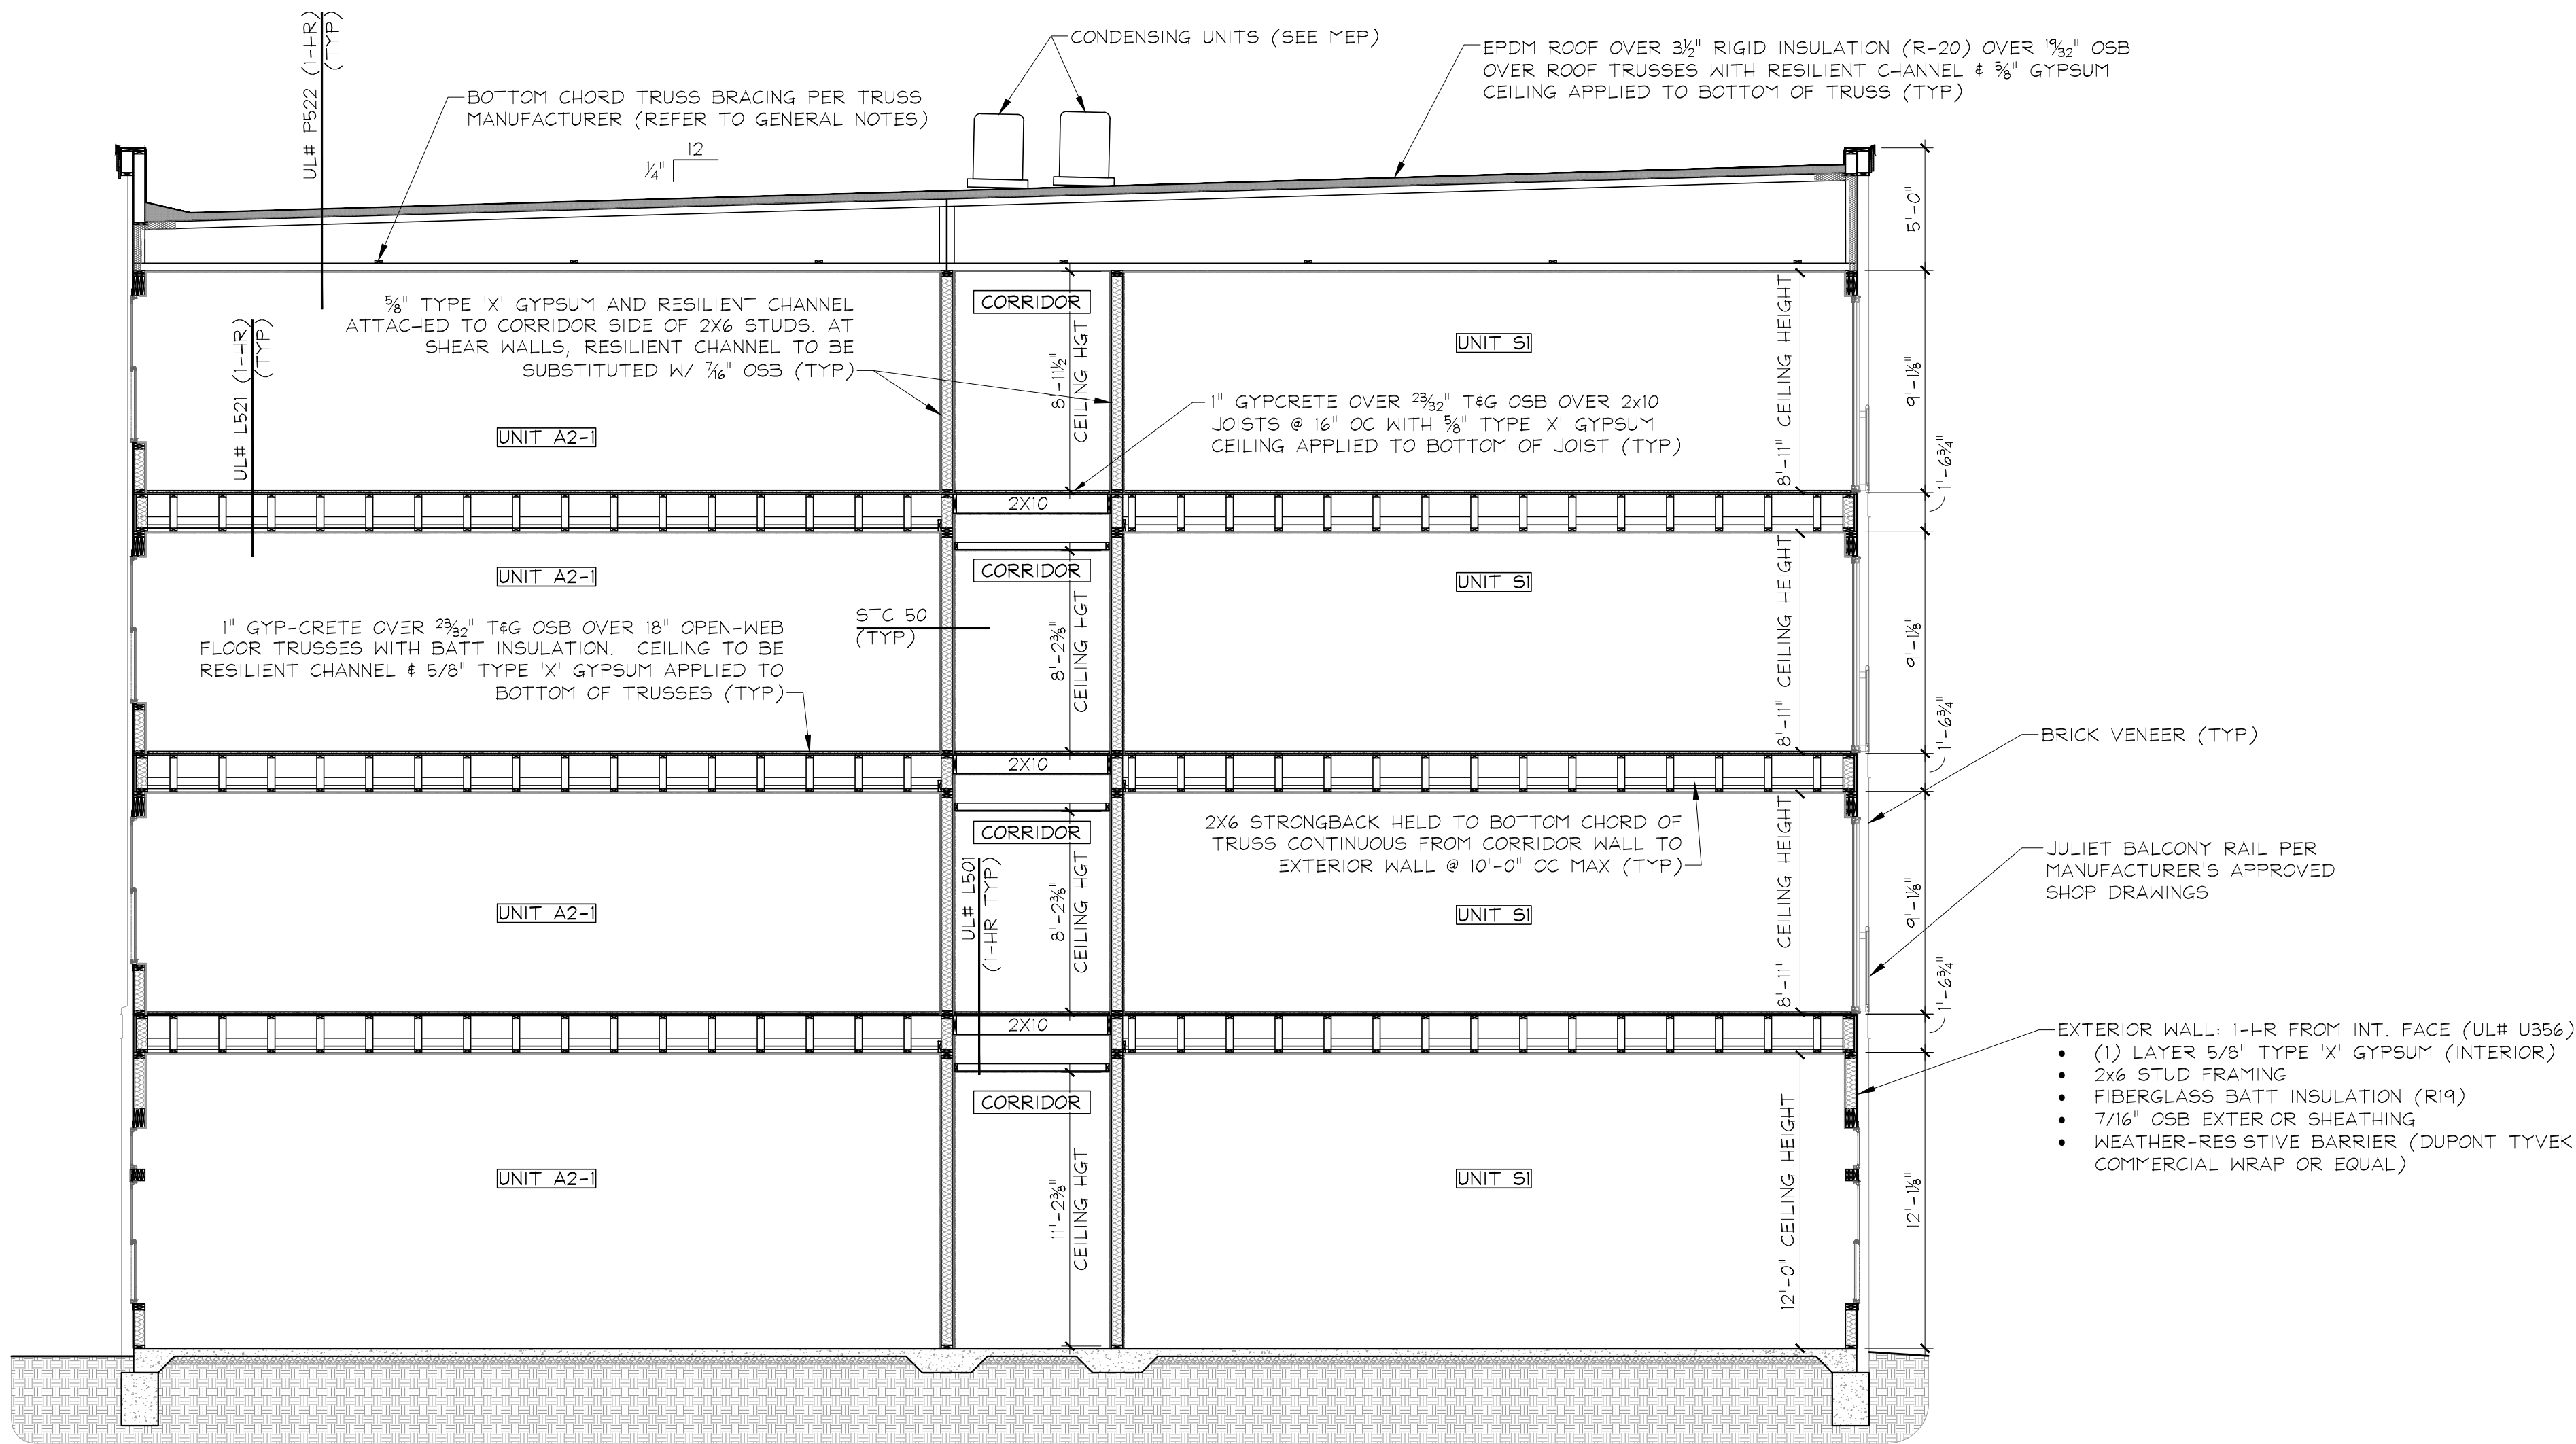

BUILDING SECTION NOTES:

- ALL DIMENSIONS ARE TO FACE OF STUD (UNO).
- SEE 'CODE REVIEW - FIRE PROTECTION' SHEETS FOR REQUIRED RATINGS AT ALL VERTICAL FIRE ASSEMBLIES (RATED WALLS) AND AS1.1-AS2.4 FOR RATINGS AT ALL HORIZONTAL FIRE ASSEMBLIES (FLOORS & ROOFS).
- SEE ENLARGED UNIT PLANS (U1.1-U1.12) FOR FLOOR COVERINGS, STC/IC RATINGS, STUD SPACING & WALL INSULATION (UNO).
- WATER-RESISTIVE BARRIER SYSTEM TO BE TYVEK OR APPROVED EQUAL AND SHALL MEET IBC 2009-SECTION 1403.2.
- SEALANT & FLASHING SYSTEMS TO BE SELECTED BY CONTRACTOR & INSTALLED IN ACCORDANCE WITH MANUFACTURER'S INSTALLATION REQUIREMENTS.
- BUILDING ENVELOPE SHALL COMPLY WITH 2009 IECC. APPLICABLE REQUIREMENTS FOR THIS BUILDING ARE SHOWN BELOW.

6.1.	ROOF:	R-20 CONTINUOUS
6.2.	EXTERIOR WALLS:	R-19
6.3.	WINDOWS:	U=0.32

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**CHROMA II**  
**MIXED-USE DEVELOPMENT**  
(CONCEPT 2.3)

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DRAWING TITLE  
**BUILDING SECTIONS**

PROJECT # <b>850</b>	DRAWING NUMBER <b>AS1.1</b>
DATE <b>02/22/19</b>	DESIGN DEVELOPMENT

